

Site Development Plans

Commercial Development


Inside Out Painting and Remodeling

100 Lowell Road

Hudson, NH

October 2, 2024


	EXISTING	PROPOSED
EDGE OF GRAVEL		
EDGE OF PAVEMENT		
PROPERTY LINE		
STONE WALL		
REBAR		
BOUND		
BOLLARD		
EASEMENT LINE		
BUILDING SETBACK LINE		
ZONING BOUNDARY		
FLOOD PLAIN BOUNDARY		
XXXX PROPERTY MAP		
TEMPORARY BENCH MARK		
CONTOURS		
SPOT ELEVATIONS		
SOILS BOUNDARY		
SCS SOIL IDENTIFICATION SYMBOL		
HISS SOIL IDENTIFICATION SYMBOL		
TREE LINE		
EVERGREEN TREE		
EVERGREEN SHRUB		
WOOD RAIL FENCE		
CHAIN LINK FENCE		
SILT SOCK		
OVERHEAD UTILITIES		
UNDERGROUND UTILITIES		
SANITARY SEWER		
WATER LINE		
GAS LINE		
RIPRAP		
GAS VALVE		
SEWER MANHOLE		
WATER GATE		
WATER SHUT OFF		
UTILITY POLE		
UTILITY POLE W/ STREET LIGHT		
GUY WIRE		
GUY POLE		
LIGHT POLE		
WALL LIGHT		
TRANSFORMER		
TEST PIT		
PERCOLATION TEST		
DRAINAGE FLOW ARROWS		
TRAFFIC FLOW ARROWS		
ACCESSIBLE PARKING		
DUMPSTER		
SIGN		

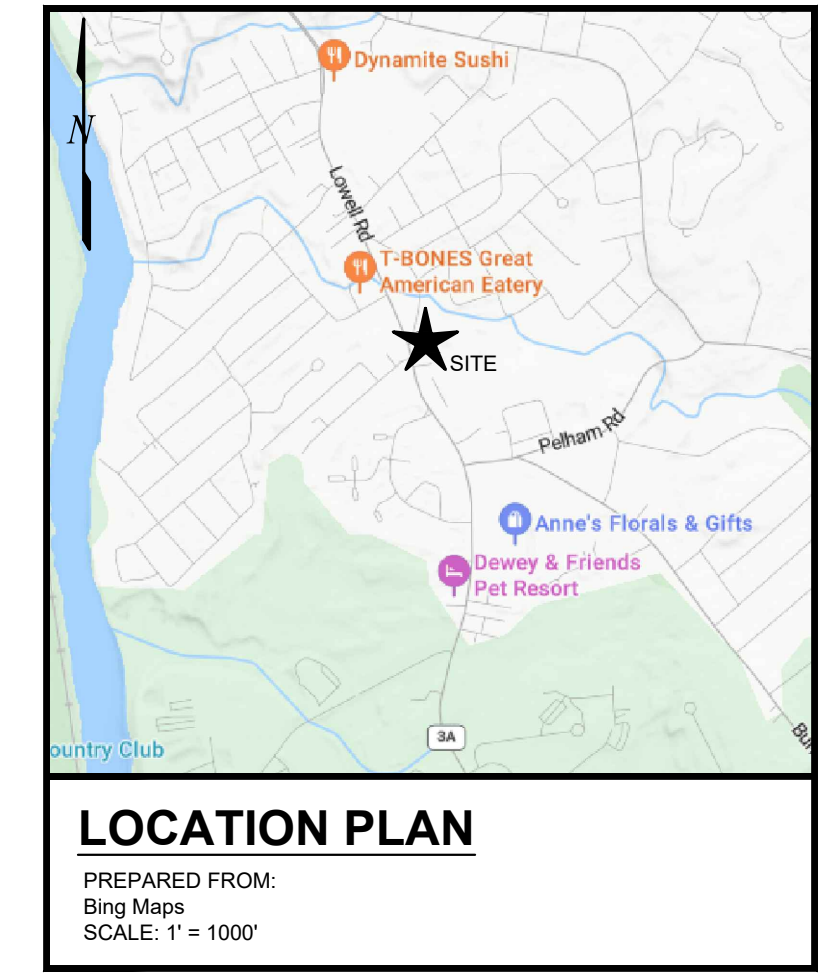

- NOTE**
1. THE PURPOSE OF THIS PLAN IS TO SHOW A GENERAL OVERVIEW OF HUDSON TAX MAP 198 LOT 147.
 2. THIS PLAN WAS PREPARED FROM THE PLANS OF REFERENCE AND THE ASSESSORS MAPS OF THE TOWN OF HUDSON.

SHEET INDEX

SHEET NUMBER	DESCRIPTION	REVISION NUMBER	DATE
1	TITLE SHEET	.	10/2/2024
2	EXISTING CONDITIONS PLAN	.	10/2/2024
3	SITE DEVELOPMENT PLAN	.	10/2/2024
4	SITE GRADING & UTILITIES PLAN	.	10/2/2024
5	LIGHTING PLAN	.	10/2/2024
6	FIRE PROTECTION PLAN	.	10/2/2024
7	EROSION CONTROL DETAILS	.	10/2/2024
8	CONSTRUCTION DETAILS	.	10/2/2024
9	CONSTRUCTION DETAILS	.	10/2/2024

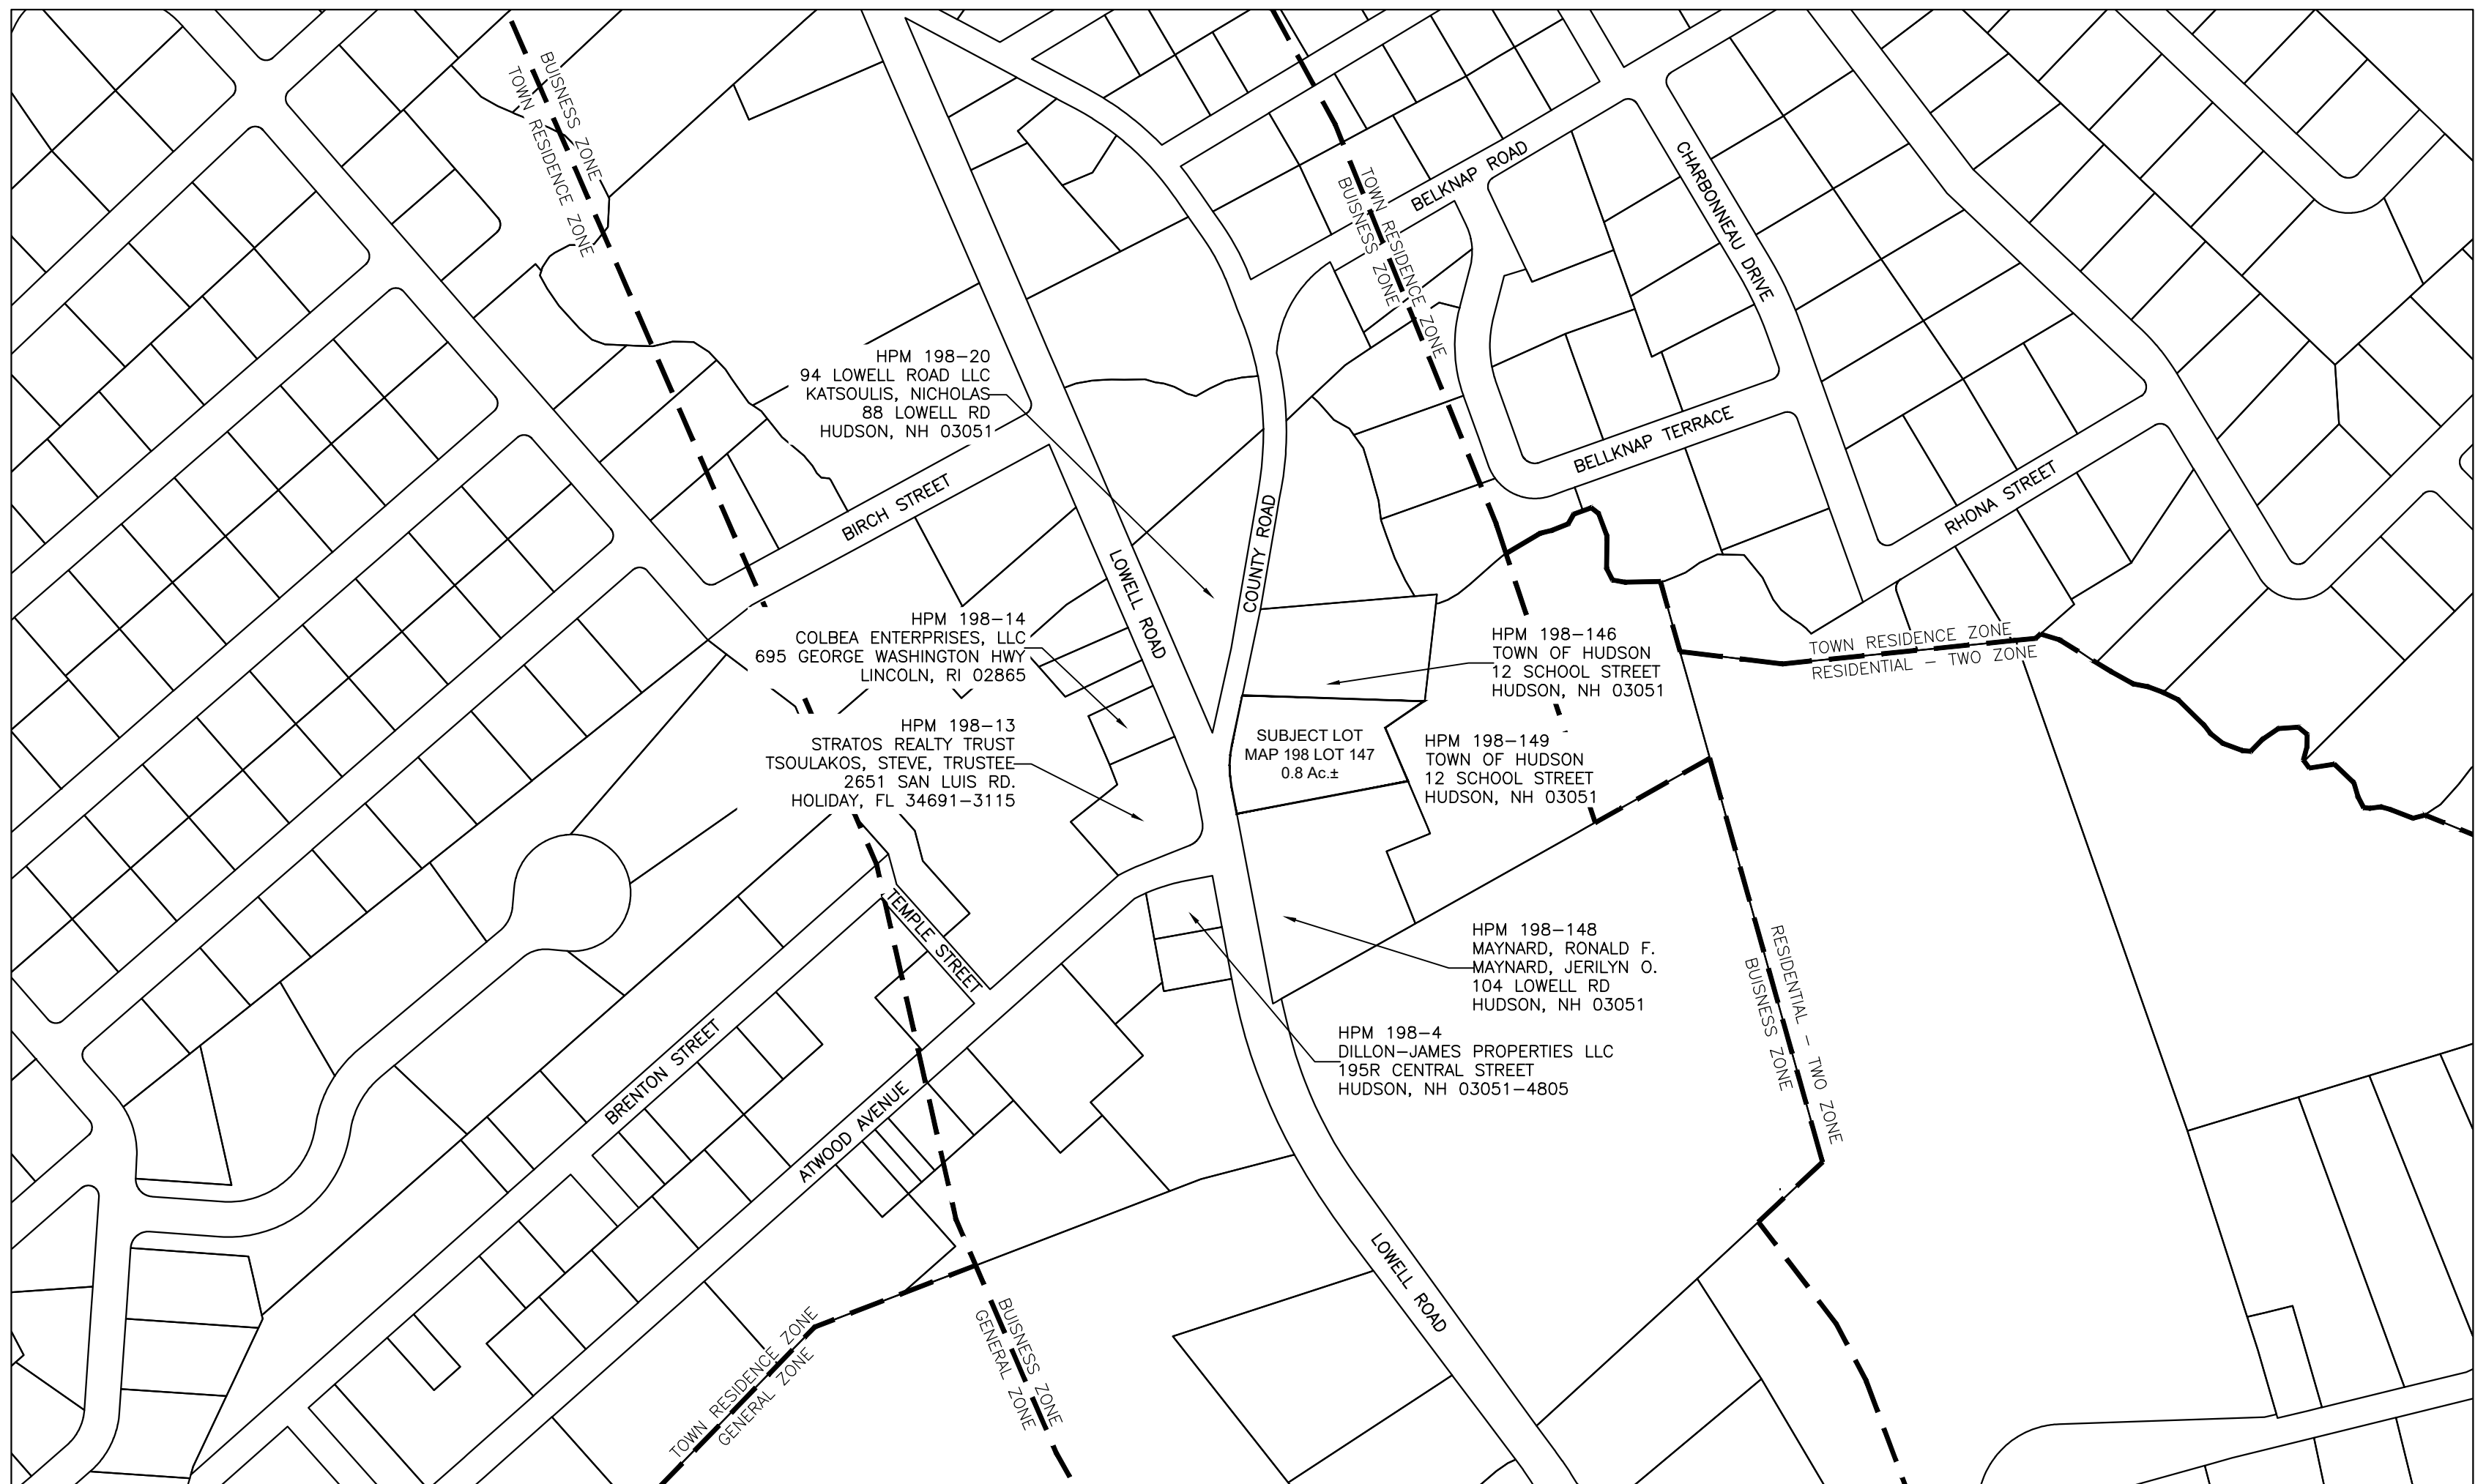

OWNER OF RECORD

100 LOWELL RD LLC
122 LOWELL ROAD, SUITE 3
HUDSON, NH 03501

SIGNATURE

No.	Revision	Date
Designed by: BRC	Drawn by: BRC	Checked by: TDD

Title Sheet
Commercial Development
Inside Out Painting and Remodeling
100 Lowell Road
Hudson, NH
Assessors Map 198 Lot 147

SFC ENGINEERING

Windham, New Hampshire
Portland, Maine

(603) 647-8700
www.sfeng.com

Sheet 1 of 9 Scale: 1" = 200' Date: 10/2/2024

	Prepared for: 100 Lowell Rd LLC 122 Lowell Road, Suite 3 Hudson, NH 03501	Hudson Planning Board Approval
	Zoning Classification: B - Business	

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APPROVED BY HUDSON, NH PLANNING BOARD

DATE OF MEETING: _____

SIGNATURE



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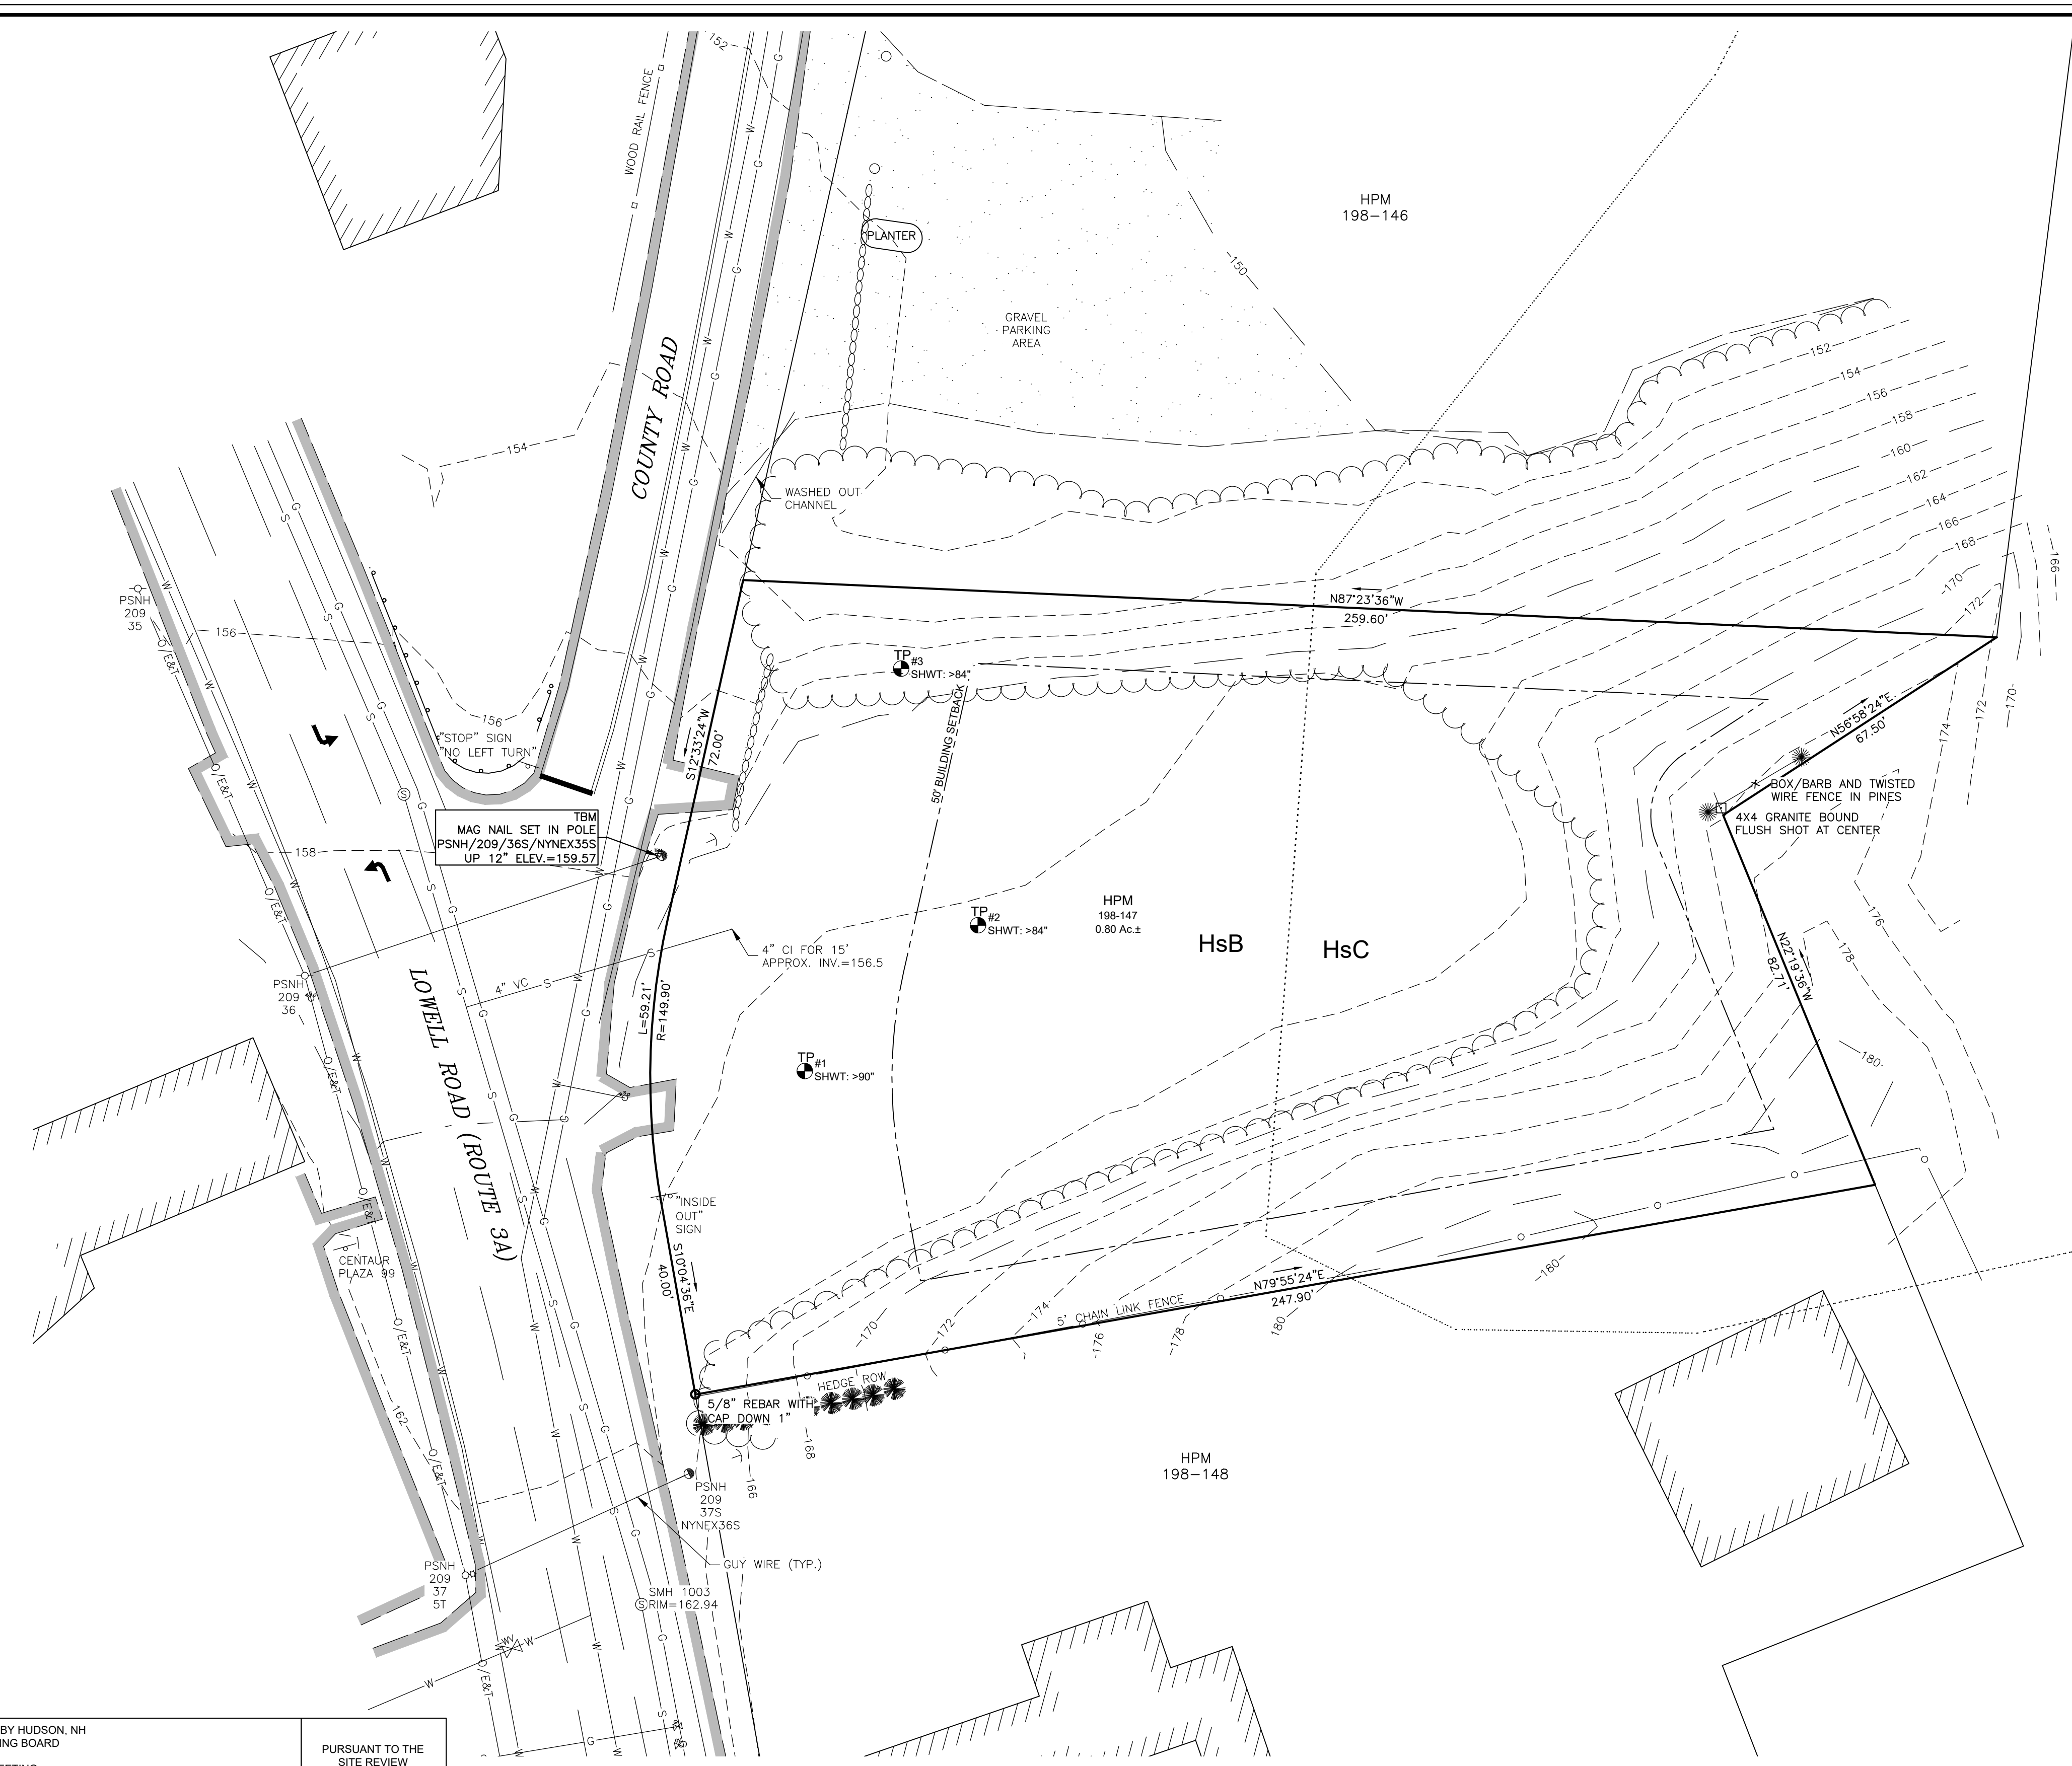
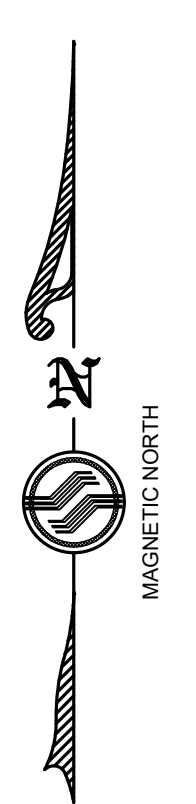
SITE PLANS ARE VALID FOR TWO YEARS FROM THE DATE OF PLANNING BOARD MEETING DATE AT WHICH THE PLAN RECEIVES FINAL APPROVAL.

PURSUANT TO THE SITE REVIEW REGULATIONS OF THE HUDSON PLANNING BOARD, THE SITE PLAN APPROVAL GRANTED HEREIN EXPIRES ONE YEAR FROM DATE OF APPROVAL.

THIS PLAN SET SUBMITTED FOR PERMITTING AND CONSTRUCTION ESTIMATES. THIS PLAN SET SHALL NOT BE USED FOR CONSTRUCTION.



Drawing name: K:\877\10 Inside Out Painting - 100 Lowell Rd Hudson NH - HamiltonAutoCAD\Final\Existing Conditions.dwg

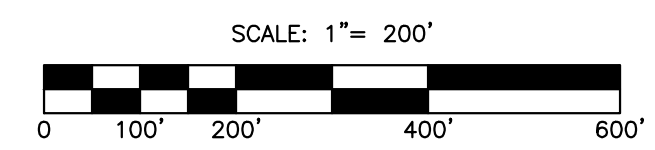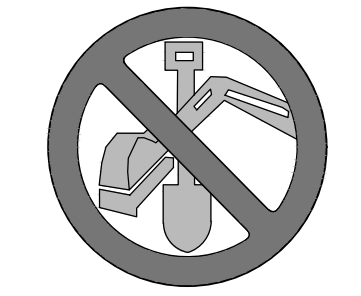

PLANS OF REFERENCE

1. "PLAN OF LAND, FELIX MAYNARD" PREPARED FOR: FELIX MAYNARD, PREPARED BY: ROLAND GIROUARD, DATED: OCT. 1969, RECORDED IN THE HILLSBOROUGH COUNTY REGISTRY OF DEEDS AS PLAN #4281
PLAN REFERENCE HUDSON, HILLSBOROUGH COUNTY REGISTRY OF DEEDS

NOTES

1. THE PURPOSE OF THIS PLAN IS TO DEPICT THE EXISTING CONDITIONS OF HUDSON PROPERTY MAP 198 LOT 147 CONSISTING OF 0.80 AC.±
2. THE OWNER OF RECORD: 100 LOWELL ROAD LLC
DEED REFERENCE BOOK 9752 PAGE 1966, HILLSBOROUGH COUNTY REGISTRY OF DEEDS
3. THIS PLAN SHOWS CONDITIONS AS DEFINED BY INSTRUMENT FIELD SURVEY ON 3/26/2024. THIS PLAN DOES NOT REPRESENT A BOUNDARY SURVEY BY SFC ENGINEERING PARTNERSHIP INC. THE PROPERTY BOUNDARY SHOWN IS BASED ON MONUMENTATION FOUND DURING THE FIELD SURVEY AND PLANS OF REFERENCE.
4. BENCHMARK: CHC 900B SURVEY GRADE GPS
VERTICAL DATUM: NAVD 83 (GEOID18)
HORIZONTAL DATUM: NAD 83
5. ZONING DISTRICT: B - BUSINESS
MINIMUM LOT SIZE: 30,000 SF
MINIMUM FRONTAGE: 150'
FRONT SETBACK: 50'
SIDE SETBACK: 15'
REAR SETBACK: 15'
6. NO PORTION OF THIS PARCEL IS LOCATED WITHIN A FLOOD HAZARD AREA AS INTERPRETED FROM THE FLOOD INSURANCE RATE MAP FOR THE TOWN OF HUDSON, MAP NUMBER 33011C0518D, EFFECTIVE DATE: SEPTEMBER 25, 2009 PREPARED BY THE FEDERAL EMERGENCY MANAGEMENT AGENCY.
7. ALL UNDERGROUND UTILITIES, IF SHOWN, ARE APPROXIMATE. CONTRACTOR TO CONTACT DIGSAFE 72 HOURS PRIOR TO CONSTRUCTION.
8. THE SITE IS SERVED BY MUNICIPAL WATER AND SEWER, OVERHEAD ELECTRIC, AND UNDERGROUND GAS.
9. SEWER UTILITY SHOWN FROM TOWN GIS AND SEWER SERVICE RECORDS.
10. WATER UTILITY SHOWN FROM TOWN GIS, WATER SERVICE RECORDS AND SURVEY LOCATIONS.
11. GAS UTILITY SHOWN FROM TOWN GIS AND SURVEY LOCATIONS.
12. THE SEWER SERVICE WAS VIEWED BY SFC AND HUDSON DPW ON AUGUST 29, 2024. THE PIPE SECTION PAST THE PROPERTY LINE TO THE SEWER MAIN IN THE ROAD WAS FOUND TO BE CLEAR AND ADEQUATE FOR SERVICE.
13. PER NRCS WEB SOIL SURVEY, SOILS INCLUDE HSB HINCKLEY LOAMY SAND, 8 TO 15 PERCENT SLOPES.
14. TEST PITS WERE OBSERVED BY SFC ON 8/29/2024

No.	Revision	Date

Designed by: JRB Drawn by: BRC Checked by: TDD

Existing Conditions Plan
Commercial Development
Inside Out Painting and Remodeling
100 Lowell Road
Hudson, NH
 Assessors Map 198 Lot 147

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ENGINEERING

Windham, New Hampshire
Portland, Maine (603) 647-8700
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Sheet 2 of 9 Scale: 1" = 20' Date: 10/2/2024



Prepared for:
100 Lowell Road LLC
122 Lowell Road, Suite 3
Hudson, NH 03501

Hudson Planning Board
Approval

Zoning Classification: B - Business

APPROVED BY HUDSON, NH
PLANNING BOARD


DATE OF MEETING: _____

SIGNATURE SIGNATURE


SIGNATURE DATE: _____ SIGNATURE DATE: _____

PURSUANT TO THE
REGULATIONS OF
THE HUDSON
PLANNING BOARD,
THE SITE PLAN
APPROVAL
GRANTED HEREIN
EXPIRES ONE YEAR
FROM DATE OF
APPROVAL.

THIS PLAN SET SUBMITTED FOR
PERMITTING AND CONSTRUCTION ESTIMATES.
THIS PLAN SET SHALL NOT BE USED FOR
CONSTRUCTION.

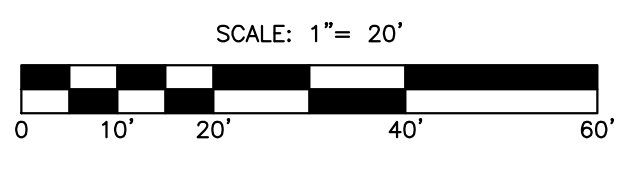

SITE PLANS ARE VALID FOR TWO YEARS FROM THE DATE OF PLANNING BOARD MEETING DATE AT WHICH THE PLAN RECEIVES FINAL APPROVAL.

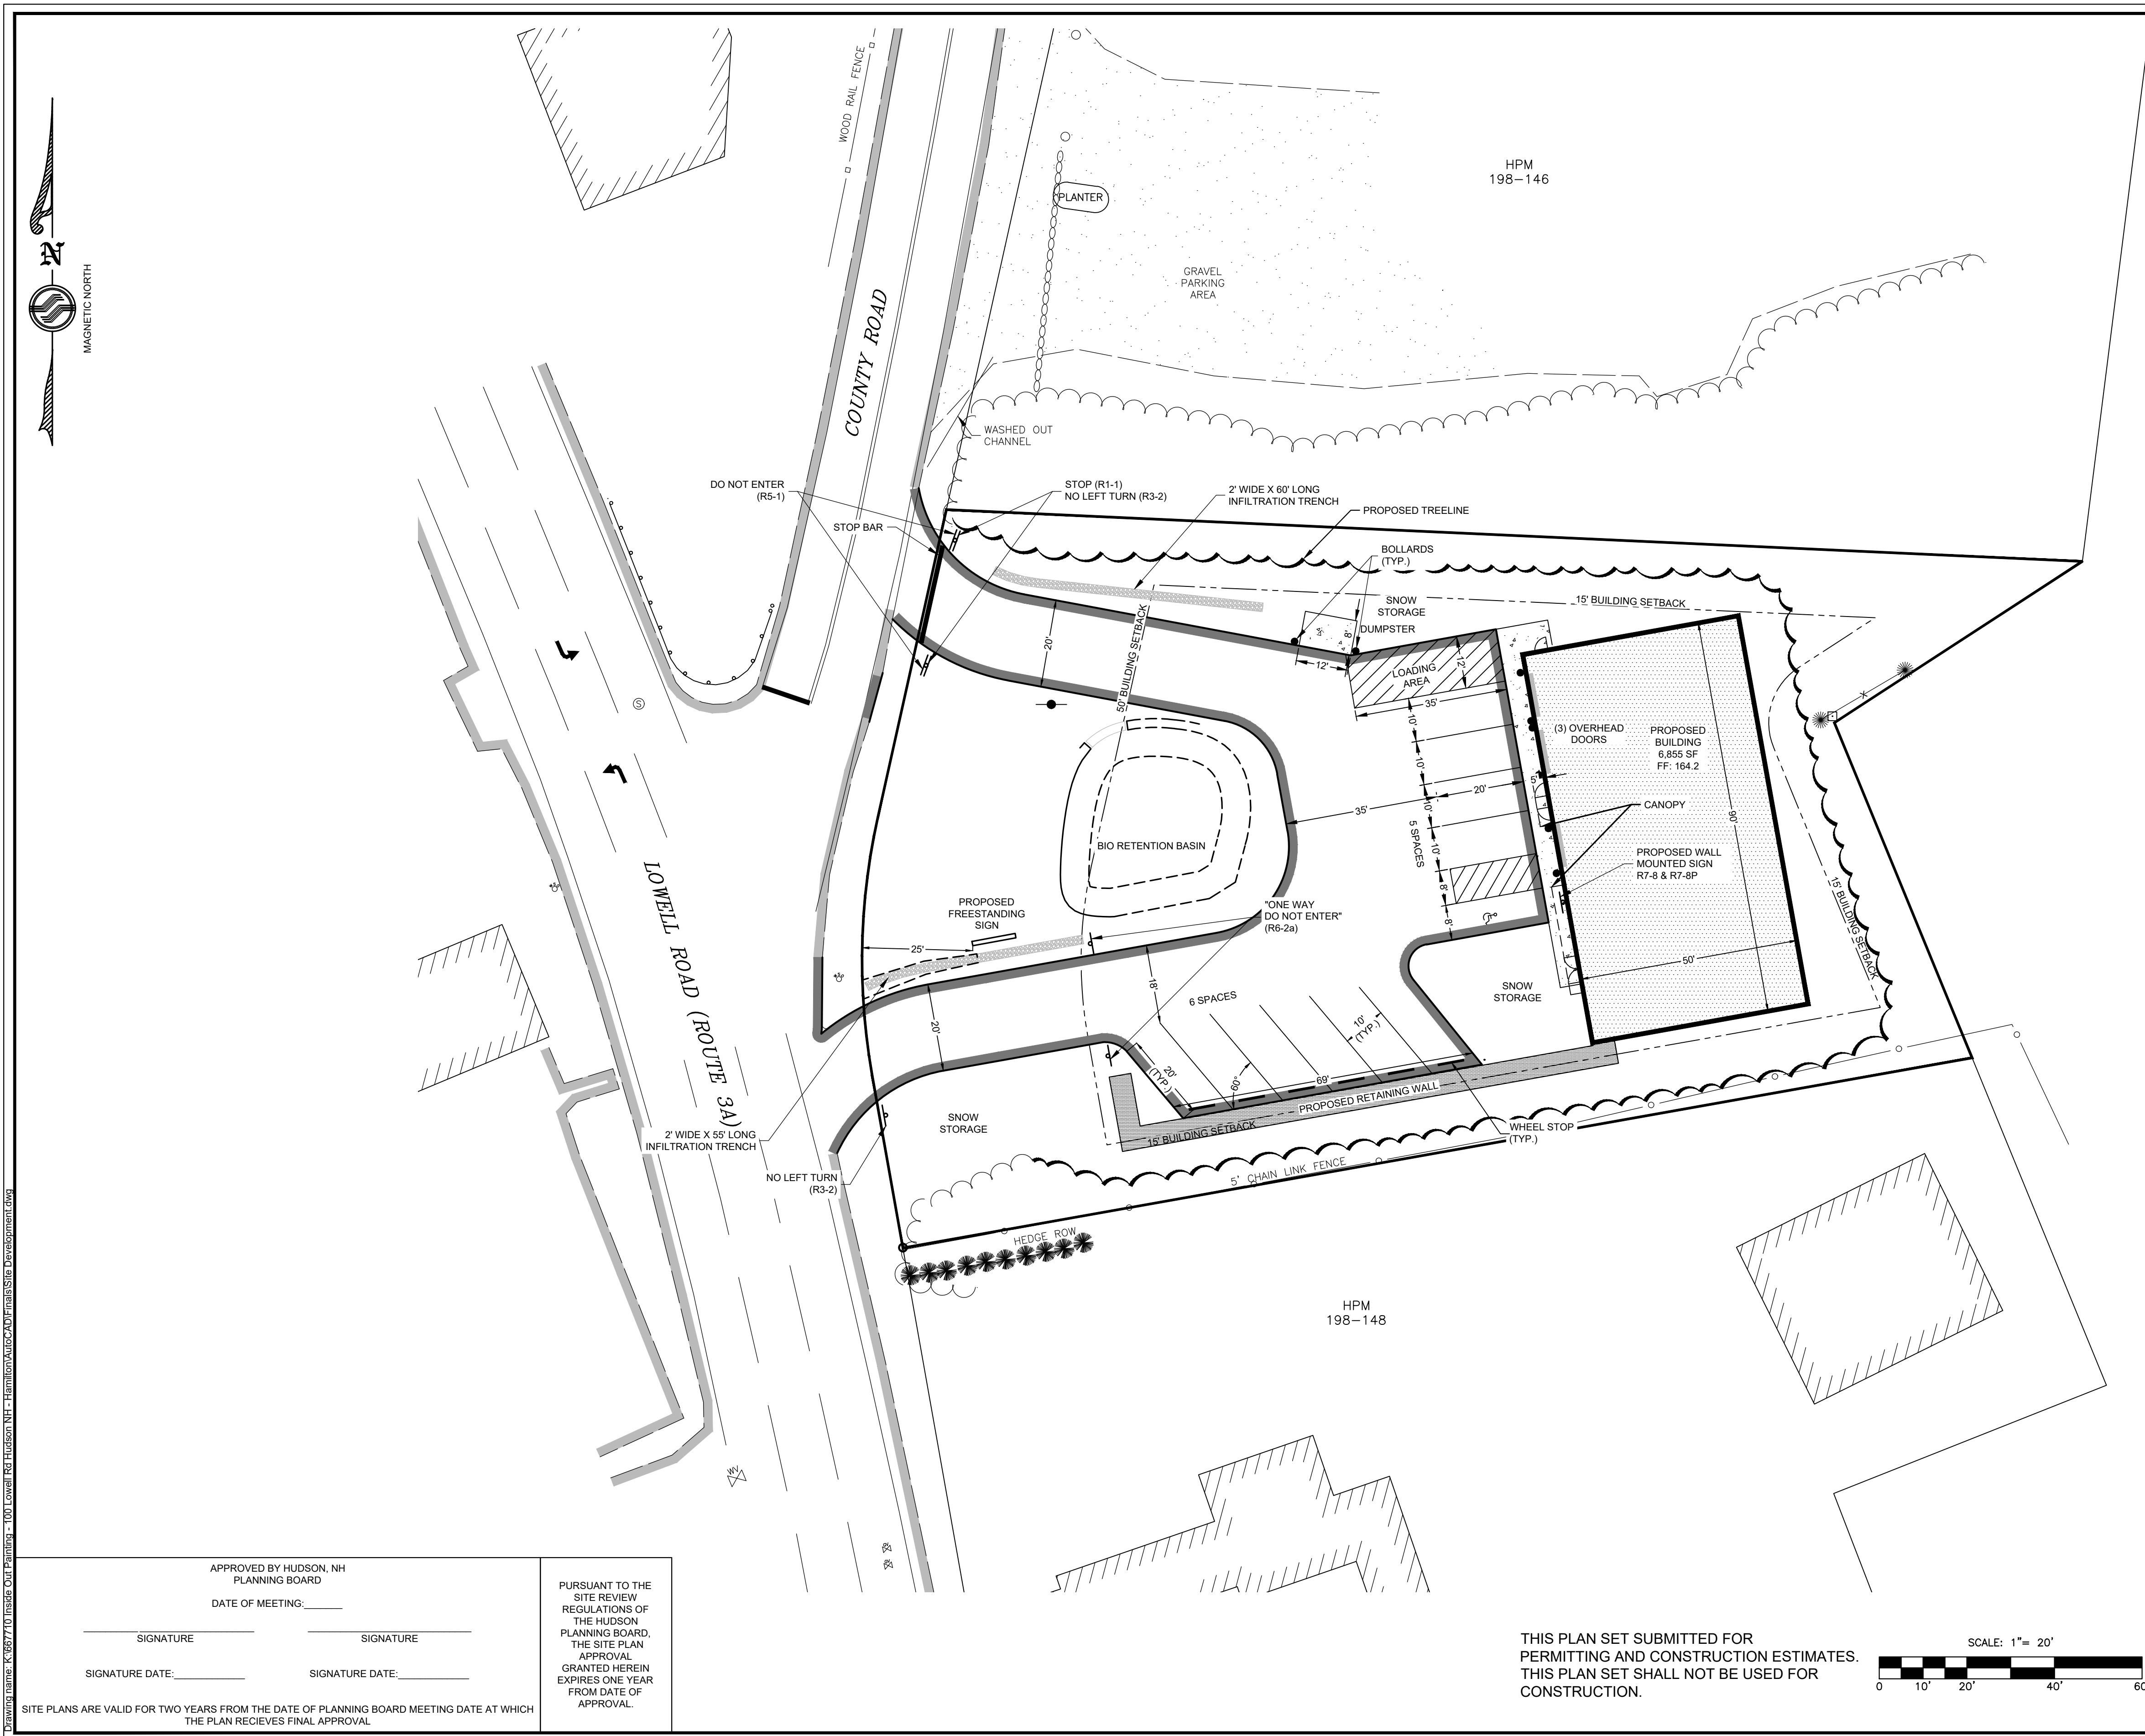

NOTES

- THE PURPOSE OF THIS PLAN IS TO DEPICT THE DEVELOPMENT OF A COMMERCIAL BUILDING ON HUDSON PROPERTY MAP 198 LOT 147 CONSISTING OF 0.80 AC.
- THE PROPOSED DEVELOPMENT INCLUDES:
 - NEW COMMERCIAL BUILDING
 - PARKING AND MANUEVERING SPACE
 - THREE OVERHEAD DOORS
 - DUMPSTER WITH ENCLOSURE
 - RETAINING WALL
 - PROPERTY TO BE SERVED BY RIGHT IN/RIGHT OUT DRIVEWAYS
 - CONNECTION TO MUNICIPAL UTILITIES (WATER AND SEWER) AND NATURAL GAS
 - RELOCATION OF OVERHEAD ELECTRIC, THEN UNDERGROUND TO BUILDING
 - NEW FREESTANDING SIGN
- ZONING DISTRICT: B - Business

DIMENSIONAL REQUIREMENT	REQUIRED	PROVIDED
MINIMUM LOT SIZE:	0.69 Ac.± (30,000 SQ.FT.)	0.8 Ac.± (34,848 SQ.FT.)
MINIMUM FRONTAGE:	150'	171'
MAXIMUM BUILDING HEIGHT:	35'	35'
FRONT SETBACK:	50'	135'
SIDE SETBACK:	15'	16'
REAR SETBACK:	15'	17'
OPEN SPACE:	13,939'	18,254'
- TOTAL LAND AREA TO BE DISTRIBUTED WITH THIS PROJECT: 9,628 SF
- TOTAL PAVEMENT ON SITE AFTER DEVELOPMENT: 9,628 SF
- THE PROPOSED BUILDING WILL BE SERVED BY MUNICIPAL WATER AND SEWER AND UNDERGROUND GAS AND ELECTRIC.
- ALL WORK IS TO CONFORM TO THE TOWN OF HUDSON STANDARDS.
- PRIOR TO CONSTRUCTION THE CONTRACTOR SHALL VERIFY THAT THEY HAVE THE MOST RECENT SET OF PLANS. ALL WORK SHALL BE PERFORMED USING THE COMPLETE SET OF PLANS AS SOME ITEMS ARE NOT SHOWN ON EVERY SHEET.
- THE ENGINEER SHALL BE NOTIFIED IMMEDIATELY IF CONDITIONS ARE FOUND THAT DO NOT MATCH WHAT IS SHOWN ON THESE PLANS
- ALL DIMENSIONS ARE TO FACE OF CURB UNLESS OTHERWISE NOTED.
- EACH ACCESSIBLE SPACE SHALL BE MARKED WITH AN UPRIGHT SIGN.
- ALL PARKING SPACES SHALL BE STRIPED WITH WHITE TRAFFIC PAINT WITH A 4" MINIMUM LINE WIDTH.
- ALL DISTURBED AREAS SHALL BE DRESSED WITH 4" OF LOAM AND SEED UNLESS OTHERWISE SPECIFIED.
- ALL SITE AND CONSTRUCTION PLANS MAY BE REVIEWED BY A THIRD PARTY CONSULTANT OF THE TOWNS CHOOSING. ALL COSTS ASSOCIATED WITH THE THIRD PARTY REVIEWS AND INSPECTION SHALL BE PAID BY THE DEVELOPER.
- OVERHEAD DOORS ARE PROVIDED FOR STORAGE OF VEHICLES DURING NON-BUSINESS HOURS TO KEEP MATERIAL IN A CONDITIONED SPACE. USE OF THESE DOORS WILL NOT IMPACT AVAILBLE PARKING.
- LOCATION OF A SIGN MEETING ZONING REQUIREMENTS IS SHOWN. ALL SIGNS ARE SUBJECT TO APPROVAL BY THE HUDSON ZONING ADMINISTRATOR PRIOR TO INSTALLATION THEREOF.
- HUDSON SITE PLAN REVIEW REGULATIONS SECTION 275-8.c(7)(e) THAT STATES THAT LANDSCAPING REQUIREMENTS DO NOT APPLY TO PARKING AREAS CONSISTING OF A SINGLE ACCESS LANE.
- PARKING REQUIREMENTS

REQUIRED: 6,855 SF / 300 SF = 23 SPACES
PROVIDED: 11, OF WHICH 1 IS VAN ACCESSIBLE

WAIVER REQUESTS


- 276-11.1.B.(9) THAT REQUIRES ERROR OF CLOSURE PREPARED BY A NH LICENSED LAND SURVEYOR.
- TOTAL 75-8.C.(2)(m) FOR PARKING QUANTITY

No.	Revision	Date

Site Development Plan
Commercial Development
Inside Out Painting and Remodeling
100 Lowell Road
Hudson, NH
 Assessors Map 198 Lot 147


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 Portland, Maine
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Sheet 3 of 9 Scale: 1" = 20' Date: 10/2/2024

	Prepared for:	Hudson Planning Board Approval
	100 Lowell Road LLC 122 Lowell Road, Suite 3 Hudson, NH 03501	

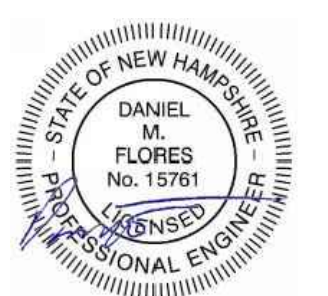Zoning Classification: B - Business

APPROVED BY HUDSON, NH PLANNING BOARD


DATE OF MEETING: _____

SIGNATURE SIGNATURE

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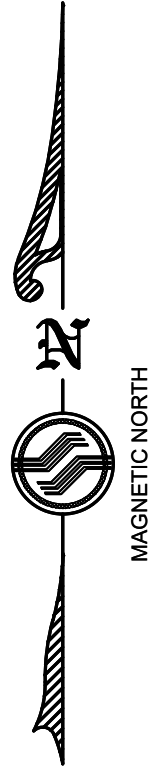
PURSUANT TO THE SITE REVIEW REGULATIONS OF THE HUDSON PLANNING BOARD, THE SITE PLAN APPROVAL GRANTED HEREIN EXPIRES ONE YEAR FROM DATE OF APPROVAL.

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Drawing Name: K:\877\10 Inside Out Painting - 100 Lowell Rd Hudson NH - Hamilton AutoCAD\Final\Site Development.dwg

SITE PLANS ARE VALID FOR TWO YEARS FROM THE DATE OF PLANNING BOARD MEETING DATE AT WHICH THE PLAN RECEIVES FINAL APPROVAL.

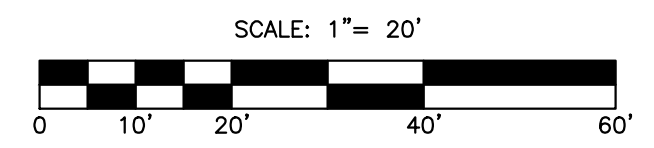

NOTES

1. THE PURPOSE OF THIS PLAN IS TO SHOW THE PROPOSED GRADING AND UTILITIES FOR DEVELOPMENT OF HUDSON PROPERTY MAP 198 LOT 147.
2. ALL WORK IS TO BE PERFORMED IN ACCORDANCE WITH TOWN OF HUDSON STANDARDS.
3. SFC ENGINEERING PARTNERSHIP, INC. DOES NOT WARRANT THE LOCATION OR ELEVATION OF THE EXISTING UTILITIES OR THAT ALL ARE SHOWN. CONTRACTOR SHALL BE RESPONSIBLE FOR CONTACTING DIG SAFE (1-800-384-7233) AT LEAST 72 HOURS PRIOR TO CONSTRUCTION IN ACCORDANCE WITH STATE LAW.
4. CONTRACTOR SHALL VERIFY TEMPORARY BENCH MARK (TBM) ELEVATIONS PRIOR TO CONSTRUCTION.
5. BENCHMARK: CHC 900B SURVEY GRADE GPS
VERTICAL DATUM: NAVD 88 (GEOID18)
HORIZONTAL DATUM: NAD 83
6. ALL SPOT GRADES ARE AT BOTTOM OF CURB UNLESS OTHERWISE SPECIFIED.
7. ALL DISTURBED AREAS SHALL BE DRESSED WITH 4" OF LOAM AND SEED UNLESS OTHERWISE SPECIFIED.
8. ALL 2:1 SLOPES SHALL BE STABILIZED WITH JUTE MATTING OR EROSION CONTROL BLANKET IMMEDIATELY FOLLOWING FINAL GRADING.
9. RETAINING WALL DESIGN BY OTHERS.
10. THE CONTRACTOR IS RESPONSIBLE FOR PROVIDING AND MAINTAINING EROSION CONTROL MEASURES THROUGHOUT CONSTRUCTION PER NH STORMWATER MANUAL. EROSION CONTROL MEASURES SHALL BE REMOVED AND PROPERLY DISPOSED OF ONCE THE SITE IS STABLE.
11. WATER SERVICE SIZE PER BUILDING DESIGN.
12. ELECTRIC SERVICE TO BE INSTALLED IN CONFORMANCE WITH UTILITY PROVIDER REQUIREMENTS.
13. ANTICIPATED SEWER LOADING:
BASED ON OFFICE USE WITH NO CAFETERIA OR SHOWERS
7 EMPLOYEES X 10 GPD = 70 GPD

No.	Revision	Date

Designed by: TDD Drawn by: BRC Checked by: DMF

Site Grading & Utilities Plan
Commercial Development
Inside Out Painting and Remodeling
100 Lowell Road
Hudson, NH
 Assessors Map 198 Lot 147



Windham, New Hampshire
Portland, Maine

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Sheet 4 of 9

Scale: 1" = 20'

Date: 10/2/2024



Prepared for:
100 Lowell Road LLC
122 Lowell Road, Suite 3
Hudson, NH 03501

Hudson Planning Board
Approval


Zoning Classification: B - Business

APPROVED BY HUDSON, NH
PLANNING BOARD
DATE OF MEETING: _____
SIGNATURE _____ SIGNATURE _____
SIGNATURE DATE: _____ SIGNATURE DATE: _____

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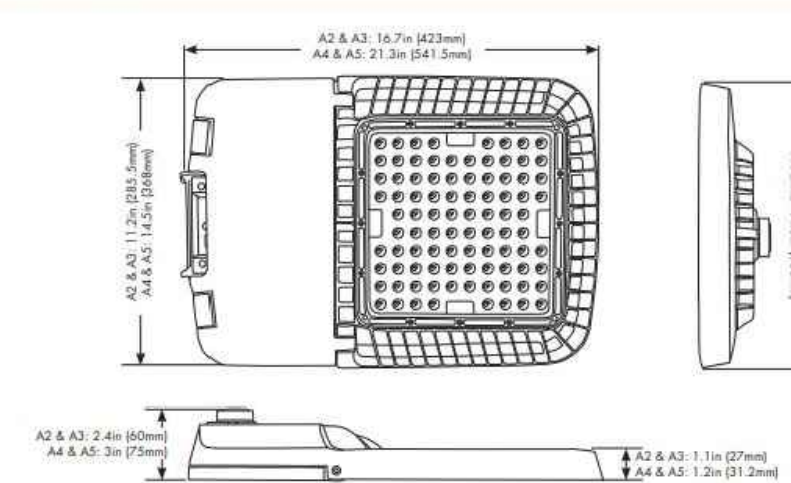
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Specifications


Input Line Voltage	120/277 & 277-480VAC
Input Line Frequency (Hz)	50/60HZ
Lumens / Wattage	14,000L (100W) 19,500L (150W) 27,500L (200W) 37,500L (300W)
Lumens per Watt (LPW)	>137 LPW
Color Temperature (CCT)	3000K, 4000K, 5000K
Rated Life	50,000 hours
Controls	NEVA 3-pin & 7-pin Photocentral Receptacle options available
Operating Temperature	-40°C to 50°C
CRI	70+
Power Factor	>0.9
Surge Protection	10KV (120-277V), 20KV (277-480V)
THD	<20%
Ratings	UL/cUL, DLC Premium 5.1, IP65 Wet Location rated

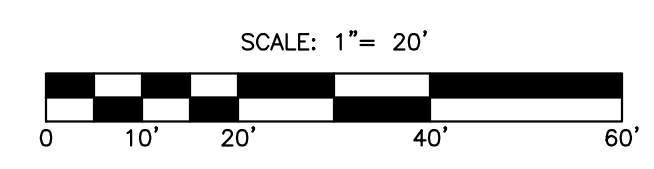

Dimensions




Mounting Diagrams

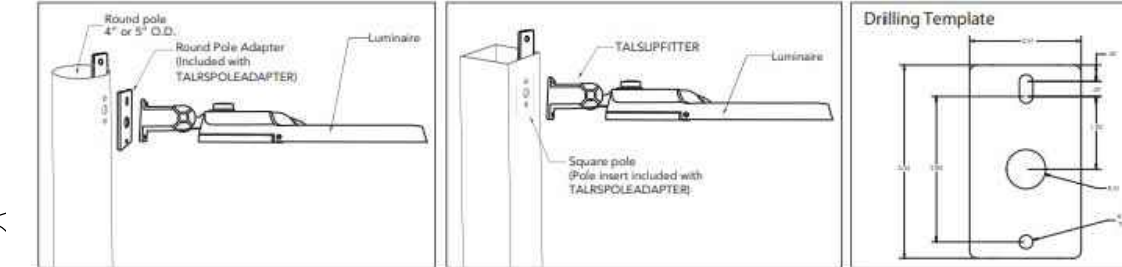

NOTES


- THE PURPOSE OF THIS PLAN IS TO SHOW THE PROPOSED LIGHTING OF THE DEVELOPMENT OF HUDSON MAP 198 LOT 147.
- PROPOSED LIGHT FIXTURES TO BE MODEL 65110W BY ESL VISION OR APPROVED EQUAL AND TO BE MODEL TALUZDAZT4F40KBR BY TCP OR APPROVED.
- PROPOSED LIGHT FIXTURES ARE FULLY SHELLED AND DARK SKY CONFORMING.
- PROPOSED LIGHT FIXTURES MOUNTING HEIGHT TO BE 20' FOR WALL PACKS AND 35' FOR LIGHT POLES.

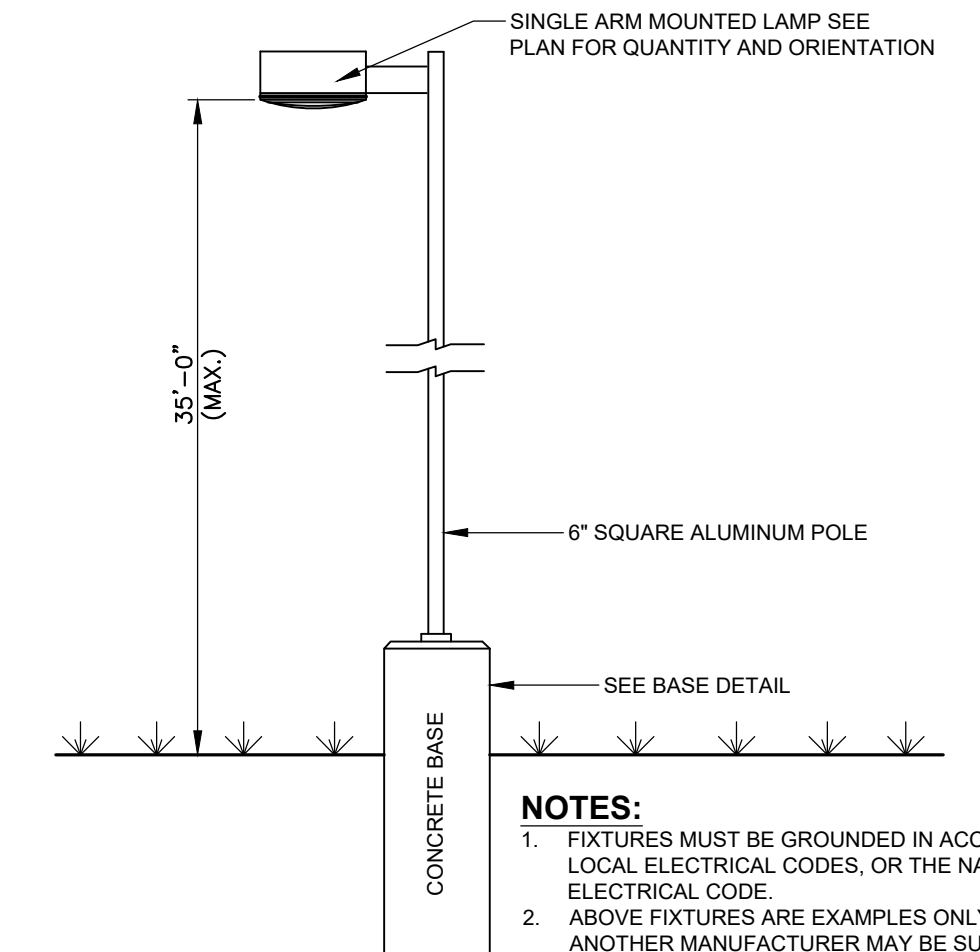

- NOTES:**
- FIXTURES MUST BE GROUNDED IN ACCORDANCE WITH LOCAL ELECTRICAL CODES, OR THE NATIONAL ELECTRICAL CODE.
 - ABOVE FIXTURES ARE EXAMPLES ONLY. FIXTURES OF ANOTHER MANUFACTURER MAY BE SUBSTITUTED PROVIDED THAT SIMILAR DISTRIBUTION PATTERNS AND LIGHTING LEVELS ARE ACHIEVED.
 - CENTER OF POLE BASES TO BE SET 4'-0" FROM EDGE OF PAVEMENT, EXCEPT WHERE OTHERWISE INDICATED ON DRAWING.
 - LIGHTING SHOWN HERE IS AREA LIGHTING. SUPPLEMENTAL BUILDING-MOUNTED FIXTURES AT DOORWAYS, ETC. MAY BE REQUIRED.

LIGHT POLE

NOT TO SCALE

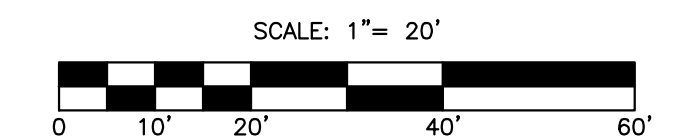

Inside Out Painting

AVERAGE BUILDING FOOT-CANDLES	.90
MAXIMUM FOOT-CANDLES	8.7
MINIMUM FOOT-CANDLES	.0
MINIMUM TO MAXIMUM FC RATIO	.00
MAXIMUM TO MINIMUM FC RATIO	8.73 / .00
AVERAGE TO MINIMUM FC RATIO	.90 / .00

Key Features & Benefits:


- Kelvin and Wattage Selectable
- Built in Photocell
- Occupancy and Emergency Options
- Stand-alone RVM Surge Protection
- Available in White and Bronze Finishes

Product Specifications:


Selectable Wattage: 65W-85W-100W
 Lumen Output: Up to 13,774 Lumens
 Efficacy (lm/W): Up to 125 Lumens per Watt
 Kelvin: 3000K-4000K-5000K
 Protection: Standard RVM Surge Protection
 CRI: >80
 Power Frequency: 50/60Hz
 Power Factor: >0.9
 Operating Temperature: -40°F to 122°F (-40°C to 50°C)
 Input Voltage: 120-277VAC
 Estimated 1% Lifetime 149,000 Hrs Calculated
 Part TM21
 Warranty: 5 Year Warranty
 Product Weight: 11.88 lbs



Dimensions:

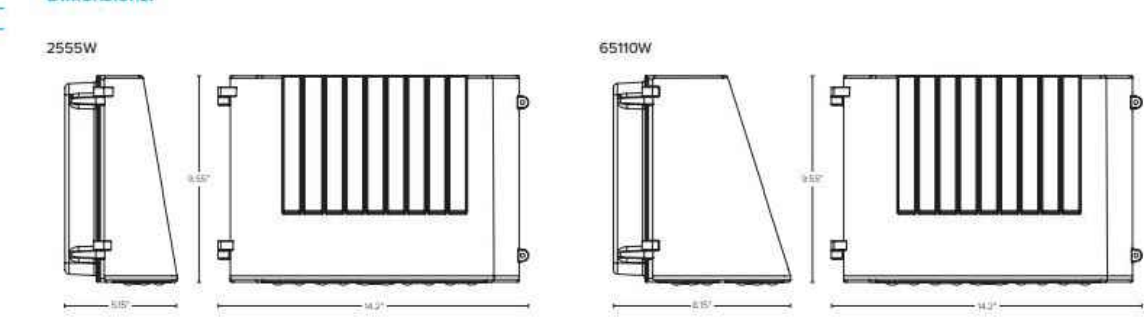

Mounting Dimensions:

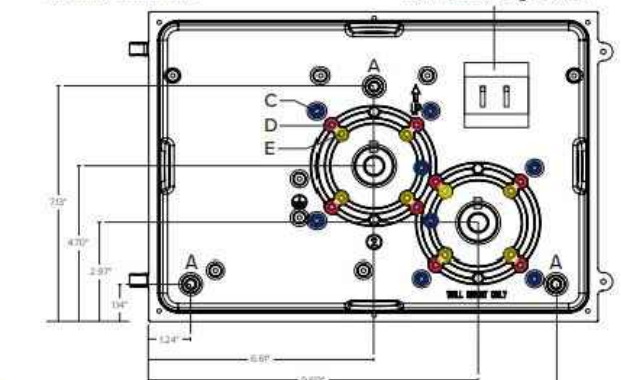

Photometric Lighting Diagram



ORDERING GUIDE:

ESL	TYPE	WATTAGE	TEMPERATURE	WARRANTY	WARRANTY	WARRANTY	WARRANTY	WARRANTY
ESL	FCMP	6550W	2	3000	5	5	5	5

WARRANTY: 5 YEAR WARRANTY

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No.	Revision	Date
Designed by: TDD	Drawn by: BRC	Checked by: DMF

Lighting Plan
Commercial Development
Inside Out Painting and Remodeling
 100 Lowell Road
 Hudson, NH
 Assessors Map 198 Lot 147

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 Portland, Maine

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Sheet 5 of 9 Scale: 1" = 20' Date: 10/2/2024

Prepared for: 100 Lowell Road LLC 122 Lowell Road, Suite 3 Hudson, NH 03501	Hudson Planning Board Approval
--	-----------------------------------

Zoning Classification: B - Business

APPROVED BY HUDSON, NH PLANNING BOARD

DATE OF MEETING: _____

SIGNATURE: _____ SIGNATURE: _____

SIGNATURE DATE: _____ SIGNATURE DATE: _____

PURSUANT TO THE REGULATIONS OF THE HUDSON PLANNING BOARD, THE SITE PLAN APPROVAL GRANTED HEREIN EXPIRES ONE YEAR FROM DATE OF APPROVAL.

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TEMPORARY SEEDING SPECIFICATIONS

REFERENCE NH STORMWATER MANUAL: VOLUME 3, REVISION 1.0

A) SITE PREPARATION

1. INSTALL NEEDED EROSION AND SEDIMENT CONTROL MEASURES SUCH AS SILTATION BARRIERS, DIVERSIONS, AND SEDIMENT TRAPS.
2. GRADE AS NEEDED FOR THE ACCESS OF EQUIPMENT FOR SEEDBED PREPARATION, SEEDING, MULCH APPLICATION, AND MULCH ANCHORING.
3. RUNOFF SHOULD BE DIVERTED FROM THE SEEDBED AREA.
4. ON SLOPES 4:1 OR STEEPER, THE FINAL PREPARATION SHOULD INCLUDE CREATING HORIZONTAL GROOVES PERPENDICULAR TO THE DIRECTION OF THE SLOPE TO CATCH SEED AND REDUCE RUNOFF.

B) SEEDBED PREPARATION

1. STONES AND TRASH SHOULD BE REMOVED SO AS NOT TO INTERFERE WITH THE SEEDING AREA.
2. WHERE THE SOIL HAS BEEN COMPACTED BY CONSTRUCTION OPERATIONS, LOOSEN SOIL TO A DEPTH OF 2 INCHES BEFORE APPLYING FERTILIZER, LIME AND SEED.
3. IF APPLICABLE, FERTILIZER AND ORGANIC SOIL AMENDMENTS SHOULD BE APPLIED DURING THE GROWING SEASON. FERTILIZER SHALL ONLY BE USED BASED ON SOIL TEST RESULTS. FERTILIZER SHALL BE RESTRICTED TO A ZERO PHOSPHATE, SLOW RELEASE NITROGEN FERTILIZER. NO FERTILIZER SHALL BE USED WITHIN THE PROTECTIVE WELL RADIUS, AND WITHIN 25 FEET OF A SURFACE WATER BODY. RATE OF APPLICATION SHALL BE PER MANUFACTURER AND SOIL TEST RESULTS.

C) SEEDING:


1. SELECT SEED FROM TABLE BELOW.
2. APPLY SEED UNIFORMLY BY HAND, CYCLONE SEEDER, DRILL, CULTIPACKER TYPE SEEDER OR HYDROSEEDER (SLURRY INCLUDING SEED AND FERTILIZER). NORMAL SEEDING DEPTH IS FROM 1/4 TO 1/2 INCH. HYDROSEEDING THAT INCLUDES MULCH MAY BE LEFT ON SOIL SURFACE. SEEDING RATES MUST BE INCREASED 10% WHEN HYDROSEEDING.
3. TEMPORARY SEEDING SHOULD TYPICALLY OCCUR PRIOR TO SEPTEMBER 15TH.
4. AREAS SEEDED BETWEEN MAY 15TH AND AUGUST 15TH SHOULD BE COVERED WITH HAY OR STRAW MULCH, ACCORDING TO THE "TEMPORARY AND PERMANENT MULCHING" PRACTICE.
5. VEGETATED GROWTH COVERING AT LEAST 85% OF THE DISTURBED AREA SHOULD BE ACHIEVED PRIOR TO OCTOBER 15TH. IF THIS CONDITION IS NOT ACHIEVED, IMPLEMENT OTHER TEMPORARY STABILIZATION MEASURES FOR OVERWINTER PROTECTION.
6. PROVIDE MULCH WHERE IT IS IMPRACTICAL TO INCORPORATE SEED INTO MOIST SOIL. THE SEEDED AREA SHOULD BE MULCHED TO FACILITATE GERMINATION. REFERENCE NH STORMWATER MANUAL: VOLUME 3 FOR TEMPORARY AND PERMANENT MULCHING REQUIREMENTS.

PLANT SELECTION AND SEEDING RATES

SPECIES	PER ACRE BUSHELS (BU) OR POUNDS (LBS)	PER 1,000 SF	REMARKS
WINTER RYE	2 BU OR 112 LBS	2.5 LBS	BEST FOR FALL SEEDING. SEED FROM MAY 15 TO JUNE 15 FOR BEST COVER. SEED TO A DEPTH OF 1 INCH.
OATS	2.5 BU OR 80 LBS	2 LBS	BEST FOR SPRING SEEDINGS. SEED NO LATER THAN MAY 15 FOR SUMMER PROTECTIONS. SEED TO A DEPTH OF 1 INCH.
ANNUAL RYEGRASS	40 LBS	1 LB	GROWS QUICKLY, BUT IS OF SHORT DURATION. USE WHERE APPEARANCES ARE IMPORTANT. SEED EARLY SPRING AND/OR BETWEEN AUGUST 15 AND SEPTEMBER 15. COVER THE SEED WITH NO MORE THAN 0.25 INCH OF SOIL.
PERENNIAL RYEGRASS	30 LBS	0.7 LB	GOOD COVER WHICH IS LONGER LASTING THAN ANNUAL RYEGRASS. SEED BETWEEN APRIL 1 AND JUNE 1 AND/OR BETWEEN AUGUST 15 AND SEPTEMBER 15. MULCHING WILL ALLOW SEEDING THROUGHOUT THE GROWING SEASON. SEED TO A DEPTH OF APPROXIMATELY 0.5 INCH.

NOTES

1. ALL MATERIAL TO MEET FILTREXX™ SPECIFICATIONS.
2. THE CONTRACTOR SHALL MAINTAIN THE COMPOST FILTER BERM IN A FUNCTIONAL CONDITION AT ALL TIMES AND IT SHALL BE ROUTINELY INSPECTED.
3. WHERE THE BERM REQUIRES REPAIR, IT WILL BE ROUTINELY REPAIRED.
4. THE CONTRACTOR SHALL REMOVE SEDIMENTS COLLECTED AT THE BASE OF THE BERM WHEN THEY REACH 1/3 OF THE EXPOSED HEIGHT OF THE BERM, OR AS DIRECTED BY THE ENGINEER.
5. THE COMPOST FILTER BERM WILL BE DISPERSED ON SITE WHEN NO LONGER REQUIRED, AS DETERMINED BY THE ENGINEER.

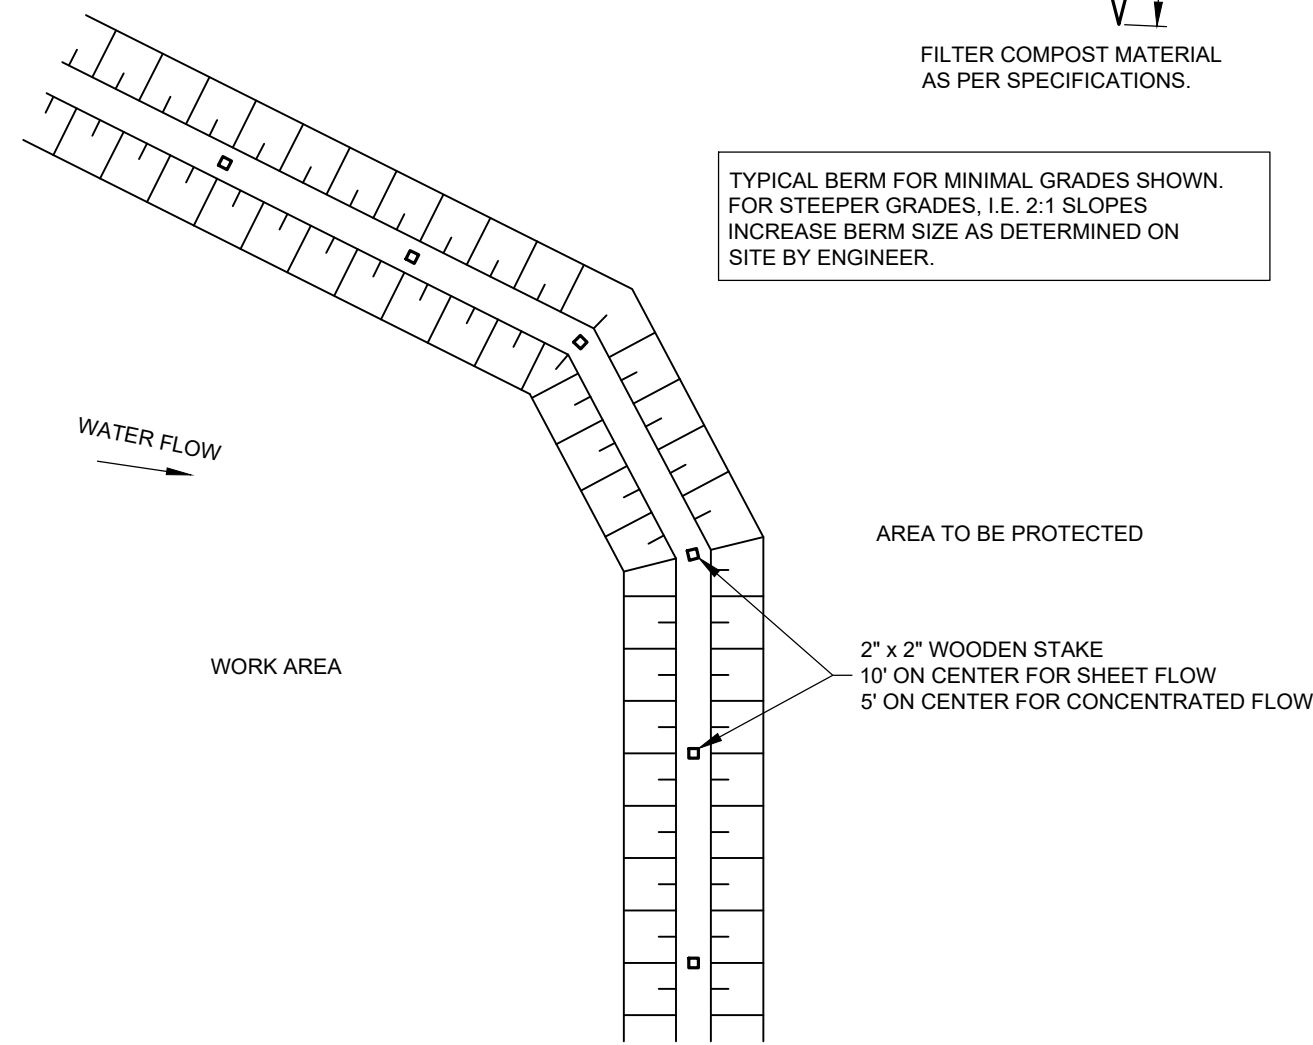

SILT SOCK INSTALLATION DETAIL


NOT TO SCALE

NOTES

- TEMPORARY SEDIMENT TRAPS SHALL COMPLY WITH THE FOLLOWING:
- (a) THE TRAP SHALL BE INSTALLED AS CLOSE TO THE DISTURBED AREA OR SOURCE OF SEDIMENT AS POSSIBLE.
 - (b) THE MAXIMUM CONTRIBUTING DRAINAGE AREA TO THE TRAP SHALL BE LESS THAN 5 ACRES.
 - (c) THE MINIMUM VOLUME OF THE TRAP SHALL BE 3,600 CUBIC FEET OF STORAGE FOR EACH ACRE OF DRAINAGE AREA.
 - (d) THE SIDE SLOPES OF THE TRAP SHALL BE 3:1 OR FLATTER, AND SHALL BE STABILIZED IMMEDIATELY AFTER THEIR CONSTRUCTION.
 - (e) THE OUTLET OF THE TRAP SHALL BE A MINIMUM OF ONE FOOT BELOW THE CREST OF THE TRAP AND SHALL DISCHARGE TO A STABILIZED AREA.
 - (f) THE TRAP SHALL BE CLEANED WHEN 50 PERCENT OF THE ORIGINAL VOLUME IS FILLED, AND
 - (g) THE MATERIALS REMOVED FROM THE TRAP SHALL BE PROPERLY DISPOSED OF AND STABILIZED.

SPECIFICATIONS

- TEMPORARY SEDIMENT TRAPS SHALL BE DESIGNED IN ACCORDANCE WITH NH STORMWATER MANUAL:
- (a) SEDIMENT TRAPS SHOULD BE LOCATED SO THAT THEY CAN BE INSTALLED PRIOR TO DISTURBING THE AREA THEY ARE TO PROTECT.
 - (b) THE MAXIMUM HEIGHT OF THE SEDIMENT TRAP EMBANKMENT SHOULD BE 4 FEET WHEN MEASURED FROM THE LOWEST POINT OF NATURAL GROUND ON THE DOWNSTREAM SIDE OF THE EMBANKMENT.
 - (c) OUTLETS SHOULD BE DESIGNED SO THAT THE TOP OF THE EMBANKMENT IS A MINIMUM OF 1 FOOT ABOVE THE CREST ELEVATION OF THE OUTLET.
 - (d) THE OUTLET SHOULD DISCHARGE TO A STABILIZED AREA AND MUST EMPTY ONTO UNDISTURBED GROUND, INTO A WATERCOURSE, STABILIZED CHANNEL OR A STORM SEWER SYSTEM.

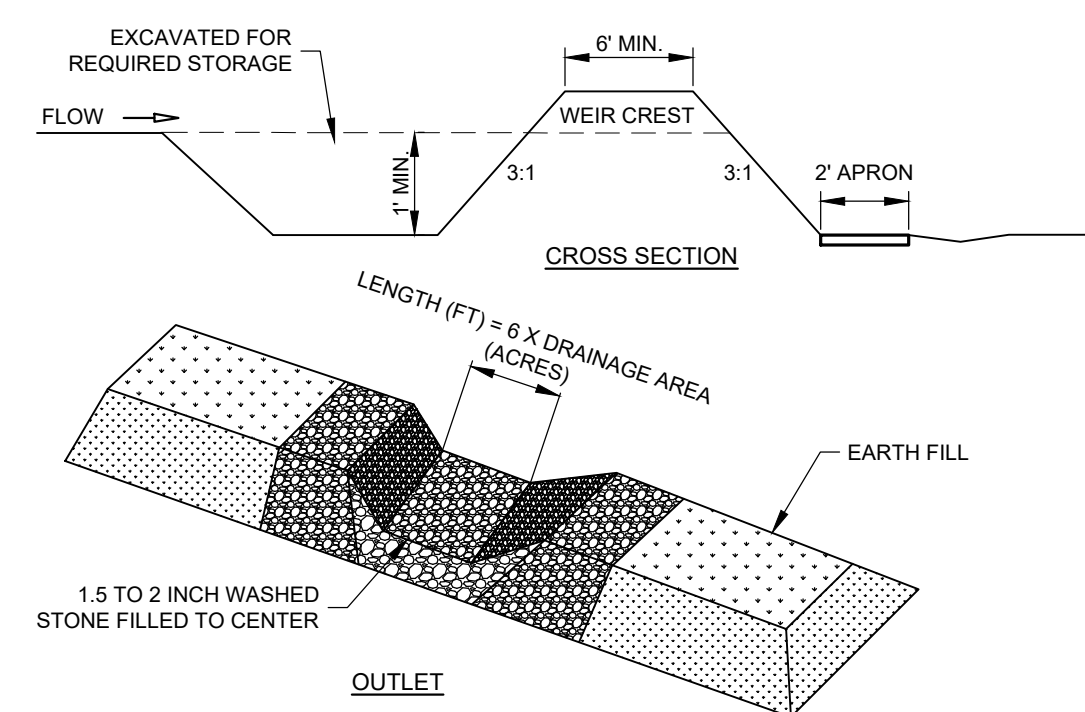

TEMPORARY SEDIMENT TRAP

NOT TO SCALE

CONSTRUCTION SEQUENCE

1. INSTALL PERIMETER EROSION CONTROL MEASURES. TEMPORARY EROSION AND SEDIMENT CONTROL PRACTICES SHALL BE INSTALLED AS SHOWN ON THE PLANS AND SHALL CONFORM TO ALL APPLICABLE SECTIONS OF THE NH STORMWATER MANUAL, VOLUME 3, DATED DECEMBER 2008.
2. CUT AND CLEAR TREES. IDENTIFY TREES TO BE SAVED AND INSTALL PROTECTIVE FENCES AROUND THESE TREES. CUT TREES, CLEAR AND DISPOSE OF DEBRIS.
3. INSTALL OTHER EROSION CONTROL MEASURES. TEMPORARY AND PERMANENT EROSION, SEDIMENT AND DETENTION PRACTICES - INCLUDING PONDS AND SWALES - SHALL BE INSTALLED PRIOR TO ROUGH GRADING. PERMANENT STORMWATER TREATMENT SYSTEMS ARE TO BE CONSTRUCTED AND SEEDED AS SOON AS PRACTICAL SO THAT VEGETATION MAY BE ESTABLISHED PRIOR TO DIRECTING RUNOFF TO THEM. ADDITIONAL STORMWATER MANAGEMENT PRACTICES SHALL BE IMMEDIATELY INSTALLED WHEN NECESSARY AND APPROPRIATE DURING CONSTRUCTION.
4. PROTECT DRAINAGE STRUCTURES. DURING CONSTRUCTION, ALL DRAINAGE INLETS SHALL BE PROTECTED BY INSTALLING A GEOTEXTILE BARRIER UNDER THE GRATE OR BY INSTALLING A STONE CHECK DAM AROUND THE PERIMETER OF THE GRATE.
5. CLEAR AND GRUB STRIP ORGANIC SOILS. LOAM SHALL BE STRIPPED FROM THE SITE AS REQUIRED. THE SMALLEST PRACTICAL AREA SHALL BE EXPOSED AT ANY TIME AND SHALL NOT EXCEED ONE ACRE. UNSTABILIZED SOIL SHALL BE TEMPORARILY STABILIZED AS SOON AS PRACTICABLE BUT NO LATER THAN 45 DAYS AFTER INITIAL DISTURBANCE.
6. STABILIZE STOCKPILES. SOIL STOCKPILES SHALL BE LOCATED AND PROTECTED TO MINIMIZE EROSION. INSTALL SILT FENCING AROUND THE BASE OF ALL STOCKPILES ON THE DOWNHILL SIDE.
7. INSPECT AND MAINTAIN ALL EROSION CONTROL MEASURES. ALL PRACTICES ARE TO BE INSPECTED AND MAINTAINED THROUGHOUT THE CONSTRUCTION PERIOD ACCORDING TO RECOMMENDED SCHEDULED, BUT AT LEAST ONCE PER WEEK, AND DURING RAINFALL EVENTS IN WHICH 1/2 INCH OF PRECIPITATION OR MORE FALLS WITHIN A 24 HOUR PERIOD. THE BOTTOM OF SEDIMENT BASINS SHALL BE PERIODICALLY CLEANED, WITH SEDIMENT REMOVED TO A SECURE LOCATION. ALL DAMAGED SILT FENCES SHALL BE REPAIRED. SEDIMENT DEPOSITS SHALL BE PERIODICALLY REMOVED.
8. GRADE AND GRAVEL AREAS TO BE PAVED. ROADWAYS AND PARKING LOTS SHALL BE GRADED, AND UNDERGROUND UTILITIES SHALL BE INSTALLED. GRAVEL SHALL BE INSTALLED AS SOON AS PRACTICAL. THESE AREAS SHALL BE STABILIZED WITHIN 72 HOURS OF ACHIEVING FINISH GRADE. ALL FILL MATERIAL SHALL BE FREE FROM STUMPS, ROOTS, WOOD, ETC.
9. STABILIZE DISTURBED AREAS. BEGIN SEED AND MULCH OF ALL DISTURBED AREAS AS SOON AS PRACTICAL, BUT NO LATER THAN THREE DAYS AFTER FINAL GRADING. ALL CUT AND FILL SLOPES SHALL BE SEEDED AND MULCHED WITHIN 72 HOURS OF ACHIEVING FINISHED GRADE. A MINIMUM OF 6\"/>
- 10. FINISH SURFACE. INSTALL FINISH SURFACE ON ROADWAYS AND PARKING LOTS.
- 11. COMPLETE PERMANENT SEEDING AND LANDSCAPING. SPREAD LOAM AND STABILIZE PER PLANS AND SPECIFICATIONS.
- 12. NO MORE THAN 5 ACRES SHALL BE DISTURBED (NOT STABILIZED) AT ANY TIME.
- 13. AN AREA SHALL BE CONSIDERED STABLE IF ONE OF THE FOLLOWING HAS OCCURRED:
 - i) BASE COURSE GRAVELS HAVE BEEN INSTALLED IN AREAS TO BE PAVED;
 - ii) A MINIMUM OF 85% VEGETATED GROWTH HAS BEEN ESTABLISHED;
 - iii) A MINIMUM OF 3\"/>
- 14. REMOVE TEMPORARY EROSION CONTROL MEASURES. AFTER CONSTRUCTION IS COMPLETED AND THE AREAS ARE STABILIZED (MINIMUM 85% VEGETATIVE COVER, BASE COURSE GRAVELS INSTALLED, 3\"/>

DUST CONTROL NOTES


1. STABILIZE SOILS AND ESTABLISH VEGETATION AS SOON AS POSSIBLE FOLLOWING EARTH DISTURBING ACTIVITIES.
2. MOISTEN EXPOSED SOIL SURFACES AS NEEDED AT A RATE OF 300 GALLONS PER ACRE. AVOID EXCESSIVE WATER APPLICATION TO PREVENT RUNOFF AND PONDING.

CONSTRUCTION SPECIFICATIONS

1. STONE FOR A STABILIZED CONSTRUCTION EXIT SHALL BE MINIMUM 3 INCH CRUSHED STONE.
2. THE MINIMUM LENGTH OF THE PAD SHOULD BE 75 FEET, EXCEPT THAT THE MINIMUM LENGTH MAY BE REDUCED TO 50 FEET IF A 3-INCH TO 6-INCH HIGH BERM IS INSTALLED AT THE ENTRANCE OF THE PROJECT SITE.
3. THE THICKNESS OF THE STONE FOR THE STABILIZED EXIT SHALL NOT BE LESS THAN 6 INCHES.
4. THE PAD SHOULD EXTEND THE FULL WIDTH OF THE CONSTRUCTION ACCESS ROAD OR 10 FEET, WHICHEVER IS GREATER.
5. GEOTEXTILE FILTER CLOTH SHALL BE PLACED OVER THE ENTIRE AREA PRIOR TO PLACING THE STONE.
6. ALL SURFACE WATER SHALL BE DIRECTED AWAY FROM THE EXIT. IF WATER IS FLOWING TOWARD THE EXIT, A BERM WITH 5:1 SLOPES THAT CAN BE CROSSED BY VEHICLES MAY BE ADDED.
7. THE PAD SHOULD BE MAINTAINED OR REPLACED WHEN MUD AND SOIL PARTICLES CLOG THE VOIDS IN THE STONE SUCH THAT THE CONTROL PAD BECOMES INEFFECTIVE AND MUD AND SOIL PARTICLES ARE TRACKED OFF-SITE.
8. NATURAL DRAINAGE THAT CROSSES THE LOCATION OF THE STONE PAD SHOULD BE INTERCEPTED AND PIPED BENEATH THE PAD, AS NECESSARY, WITH SUITABLE OUTLET PROTECTION.

MAINTENANCE

1. WHEN THE CONTROL PAD BECOMES INEFFECTIVE, THE STONE SHOULD BE REMOVED ALONG WITH THE COLLECTED SOIL MATERIAL, REGRADED ON SITE AND STABILIZED. THE EXIT SHOULD THEN BE RECONSTRUCTED.
2. THE CONTRACTOR SHOULD SWEEP THE PAVEMENT AT EXITS WHENEVER SOIL MATERIALS ARE TRACKED ONTO THE ADJACENT PAVEMENT OR TRAVELED WAY.
3. WHEN WHEEL WASHING IS REQUIRED, IT SHOULD BE CONDUCTED ON AN AREA STABILIZED WITH AGGREGATE, WHICH DRAINS INTO AN APPROVED SEDIMENT-TRAPPING DEVICE. ALL SEDIMENT SHOULD BE PREVENTED FROM ENTERING STORM DRAINS, DITCHES, OR WATERWAYS.

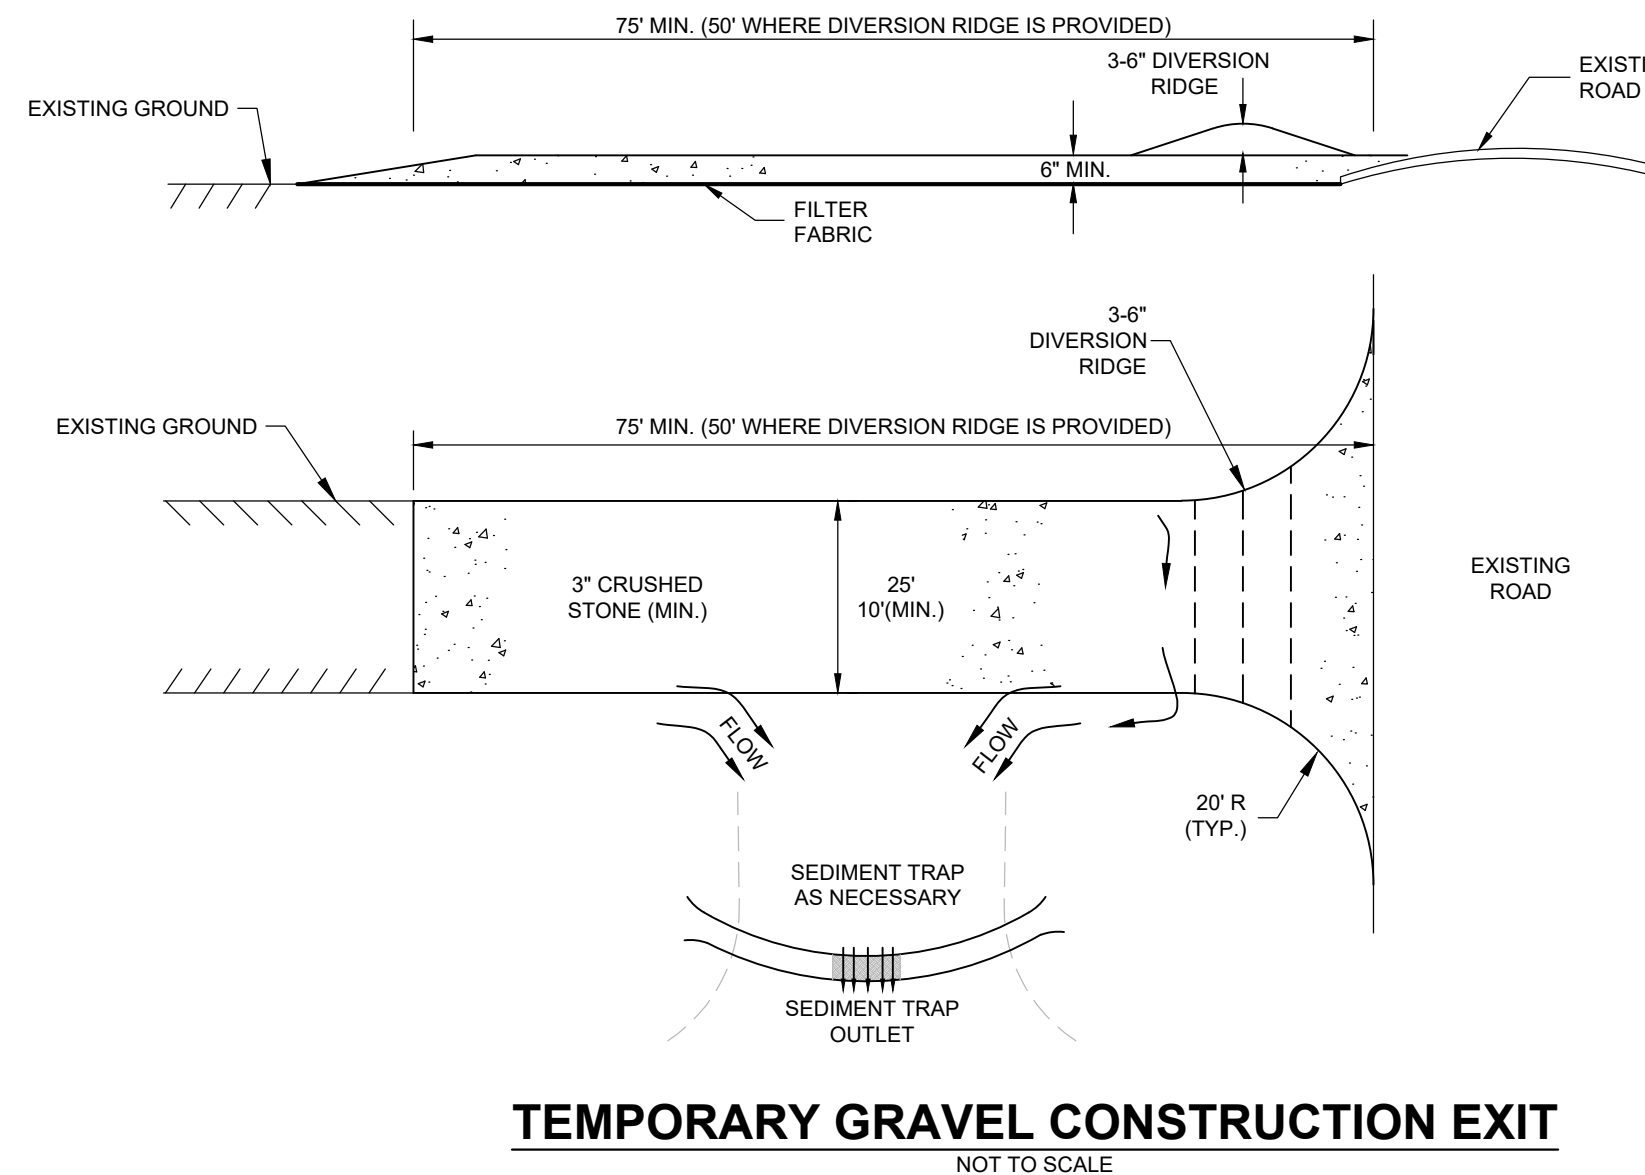

TEMPORARY GRAVEL CONSTRUCTION EXIT

NOT TO SCALE


No.	Revision	Drawn by:	Date
		BRC	

Designed by: TDD	Checked by: DMF
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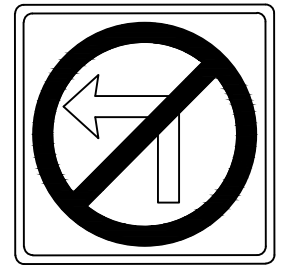
Erosion Control Details
Commercial Development
Inside Out Painting and Remodeling
100 Lowell Road
Hudson, NH
 Assessors Map 198 Lot 147

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 Portland, Maine
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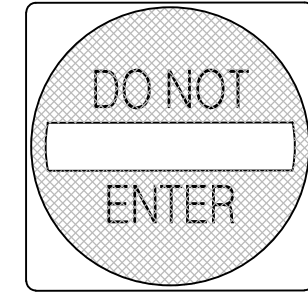
Sheet 7 of 9 Scale: 1" = 20' Date: 10/2/2024

	Prepared for:	Hudson Planning Board Approval
	100 Lowell Road LLC 122 Lowell Road, Suite 3 Hudson, NH 03501	Zoning Classification: B - Business


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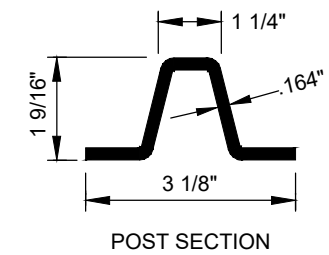
R3-2
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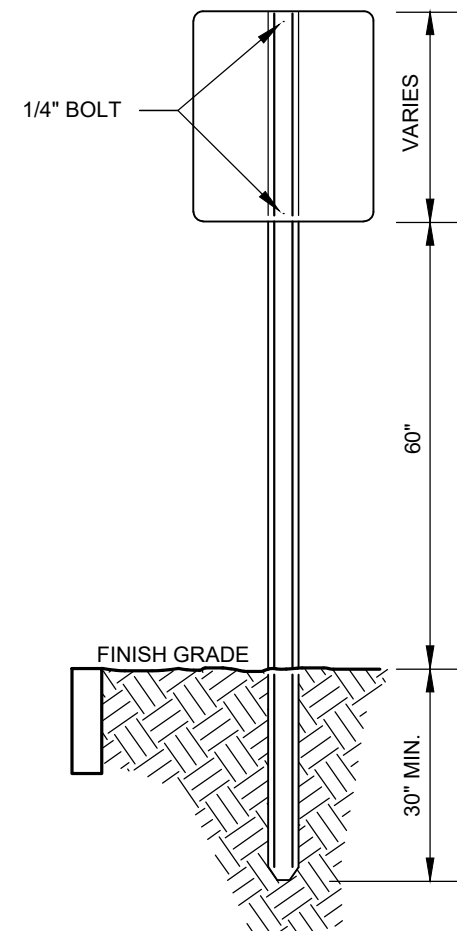
R5-1
30"X30"



R1-1
30" X 30"




POST SECTION

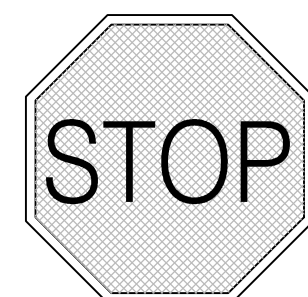


SIGN INSTALLATION DETAIL

NOT TO SCALE

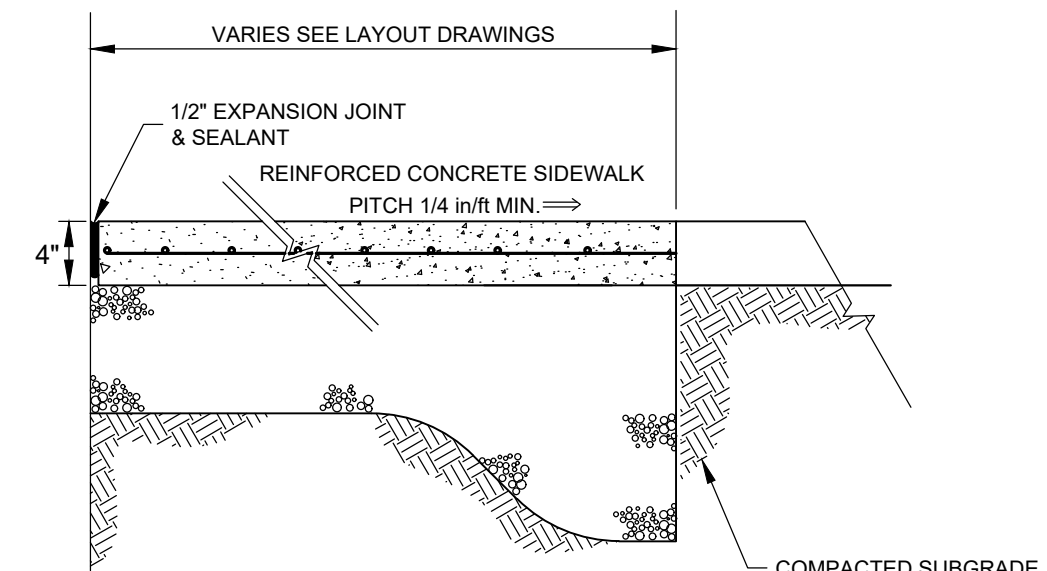

SIDEWALK DETAIL

NOT TO SCALE

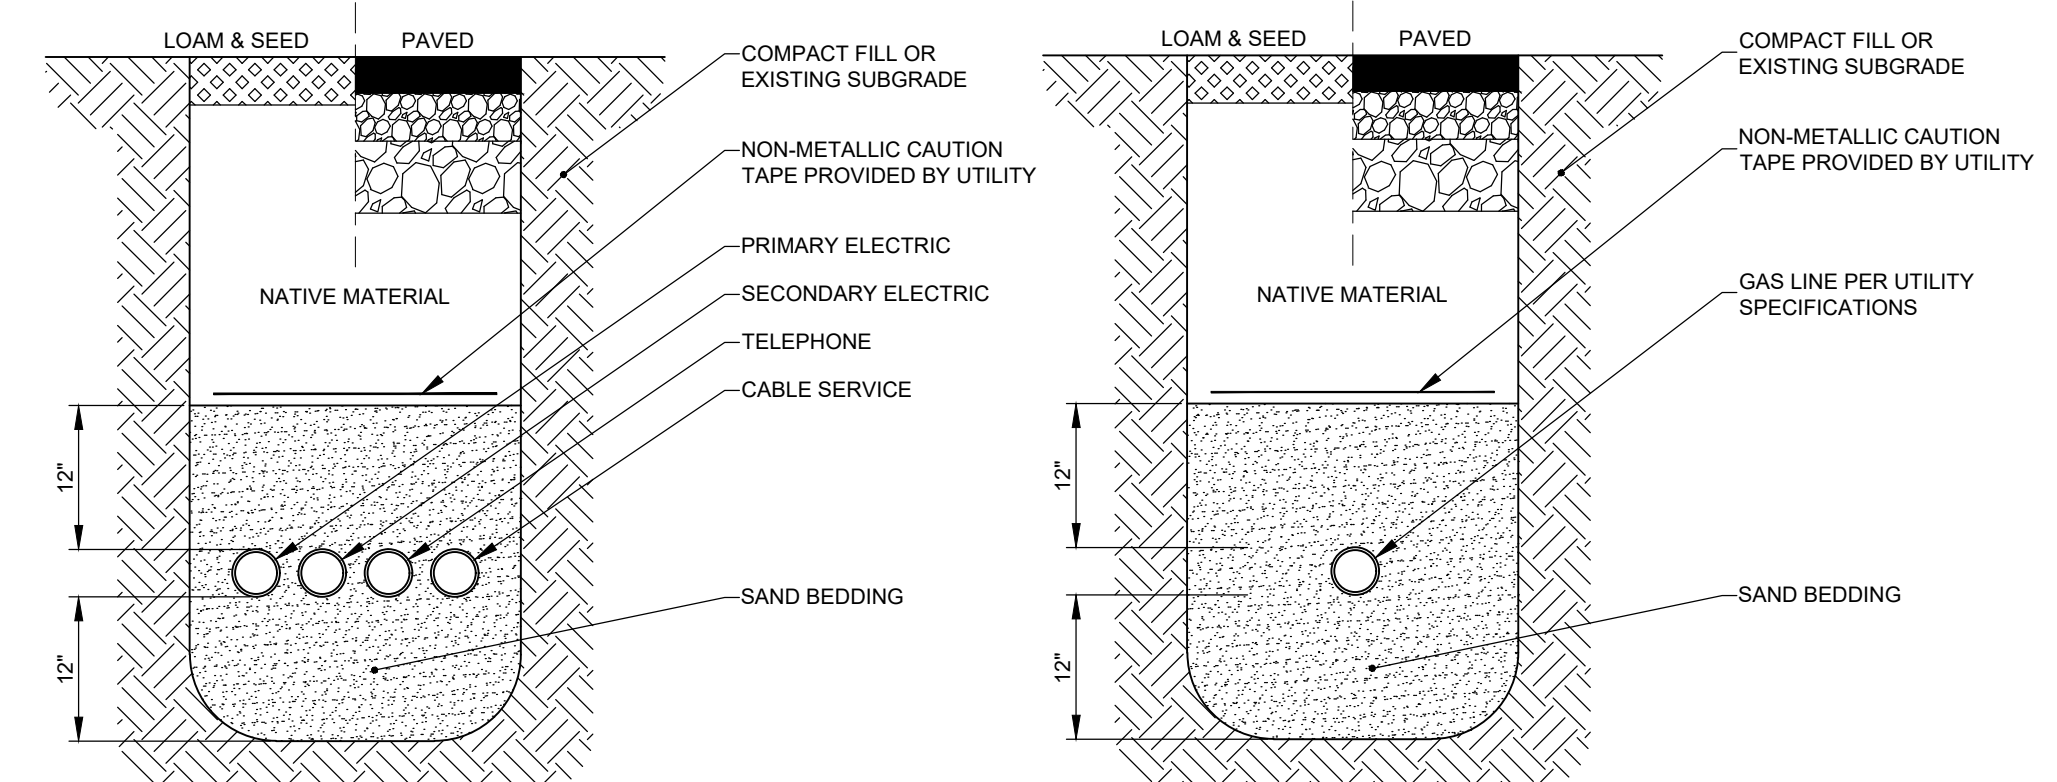

UTILITY TRENCH

- NOT TO SCALE
- NOTES:**
1. ALL FILL MATERIAL TO BE PLACED IN LIFTS NO GREATER THAN 12 INCHES.
 2. ALL FILL MATERIAL TO BE COMPACTED TO 95% OF THE MAXIMUM DRY DENSITY.
 3. MINIMUM COVER OF THREE FEET IS REQUIRED FOR ALL CONDUIT PIPES, UNLESS OTHERWISE SPECIFIED BY THE ENGINEER.
 4. CONDUIT SIZE, MATERIAL, AND INSTALLATION TO MEET UTILITY COMPANIES STANDARD SPECIFICATIONS.
 5. MINIMUM TRENCH WIDTH SHALL ALLOW FOR A MINIMUM OF 6 INCH CLEARANCE FROM TRENCH SIDE WALLS.

UTILITY TRENCH


NOT TO SCALE

TRACE WIRE NOTES:

THE TRACER WIRE SHALL BE INSTALLED ON TOP OF THE BURIED UTILITY CROWN. THE TRACER WIRE SHALL BE POSITIVELY ATTACHED TO THE NON-METALLIC BURIED UTILITIES BY PLASTIC WIRE TIES OR SIMILAR TYPE OF ATTACHMENT EVERY 10 FEET FOR STRAIGHT RUN OF UTILITY AND AT ALL CHANGES OF DIRECTION. IF TAPE IS USED IT SHALL BE POLYKEN "930-35," PROTECTO-WRAP "310," OR EQUAL. THE TERMINATION ENDS OF THE TRACER WIRE SHALL BE GROUNDED WITH 7 LB. OR LARGER ANODE BAGS WITH THE CONNECTORS HEREIN SPECIFIED. INSTALL APPROVED CAST IRON VALVE BOXES AT ALL LOCATIONS WHERE THE ENDS OF THE TRACER WIRE ARE EXPOSED ABOVE THE FINISHED GRADE. THE BOXES SHALL CONTAIN A 24' COIL OF WIRE FROM EACH END OF THE TRACER WIRE. TRACER WIRE SHALL BE CONTINUOUS BETWEEN BOXES AND SHALL BE TESTED FOR CONTINUITY IN THE PRESENCE OF THE INSPECTOR. TRACER WIRE SHALL BE MINIMUM NO. 12 AWG. COPPER WIRE OR COPPER CLAD STEEL HIGH STRENGTH WITH A MINIMUM 450 LB. BREAK LOAD WITH A MINIMUM 30 MIL. HDPE INSULATION THICKNESS (BLUE IN COLOR FOR USE WITH POTABLE WATER, GREEN FOR USE WITH SEWER). CONNECTORS SHALL BE COPPERHEAD SNAKEBITE, 3M DBR OR DRY-CON TYPE CONNECTORS FOR SPECIFIED WIRE GAGE AND SUITABLE FOR USE WITH BURIED TRACER WIRE.


GAS TRENCH

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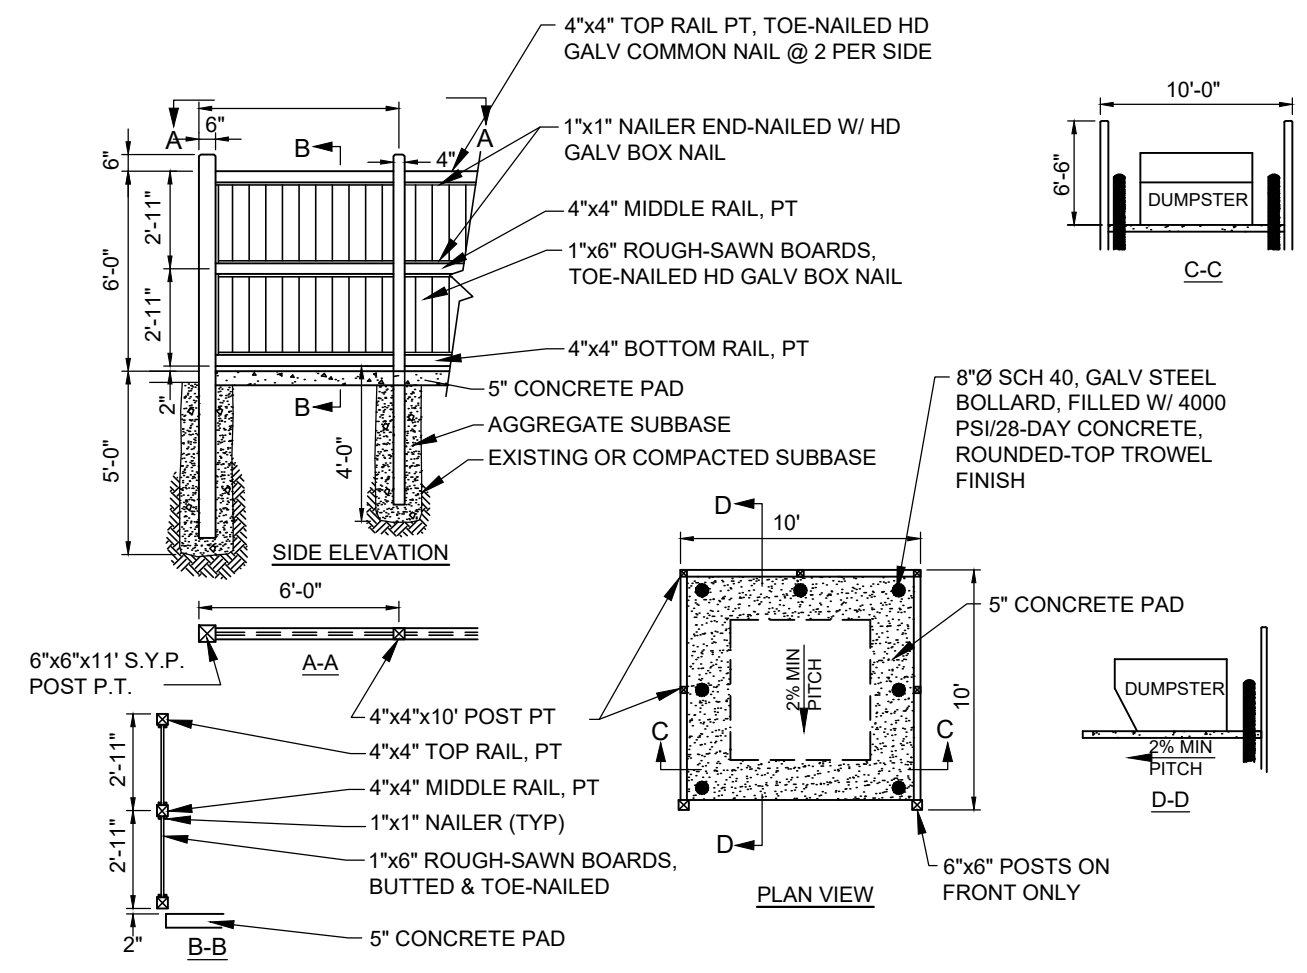
TYPICAL RETAINING WALL SECTION

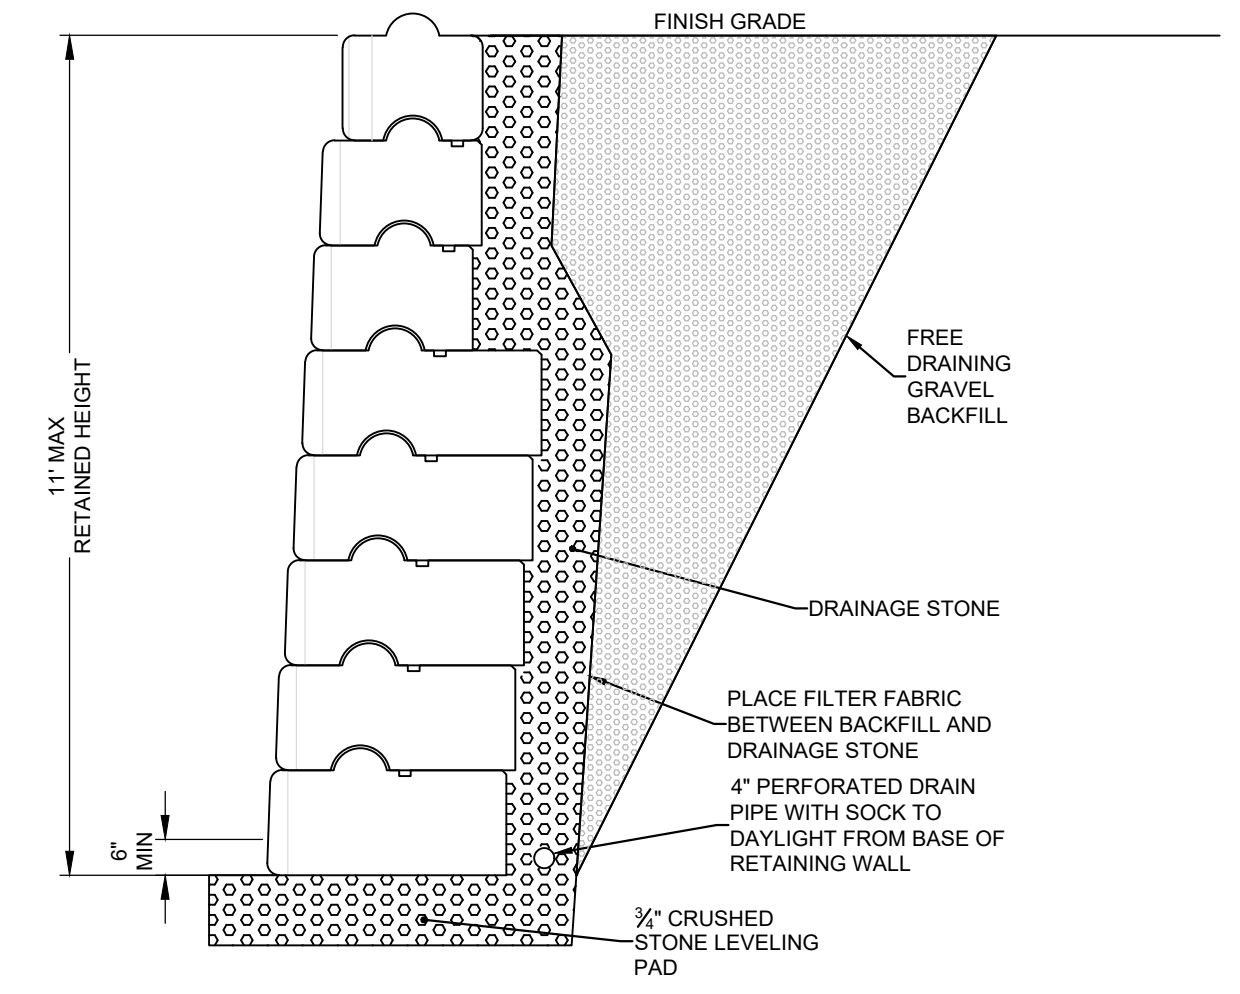NOT TO SCALE




STANDARD PAVEMENT DETAIL

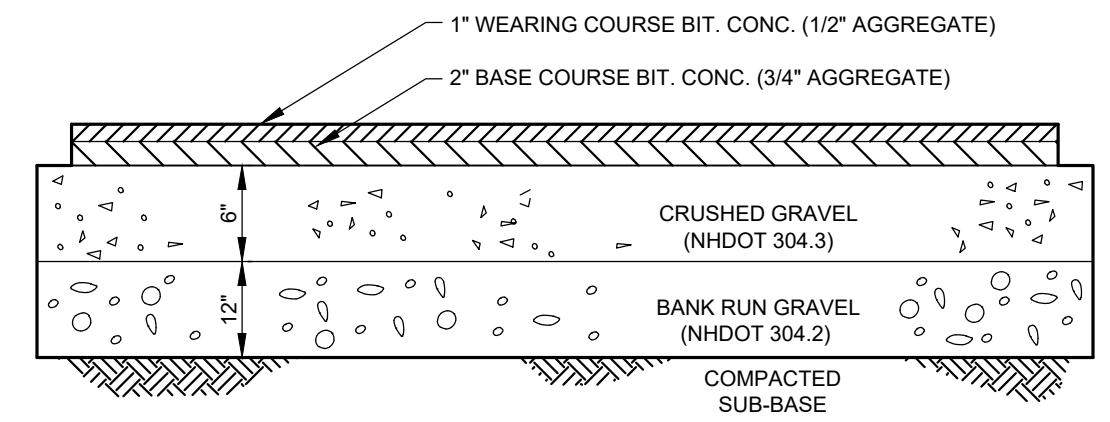NOT TO SCALE



DUMPSTER PAD AND ENCLOSURE

NOT TO SCALE

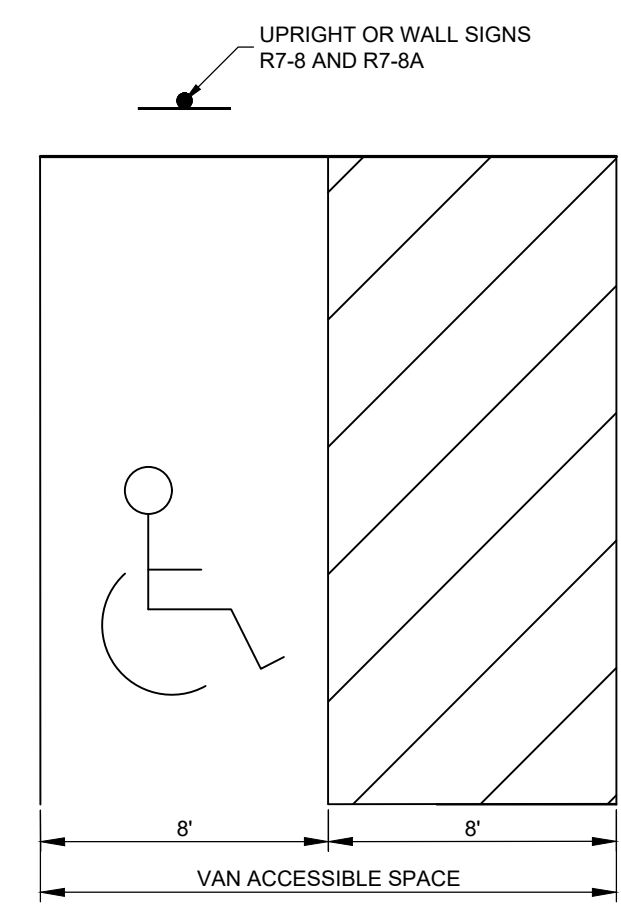

ACCESSIBLE PARKING SPACE

NOT TO SCALE

- NOTES:**
1. ALL DIMENSIONS TO CENTER OF STRIPING.
 2. ALL STRIPING SHALL BE 4" SOLID YELLOW OR WHITE PAVEMENT MARKING PAINT.
 3. ONE IN EVERY SIX ACCESSIBLE SPACES, BUT NOT LESS THAN ONE, SHALL BE "VAN ACCESSIBLE".
 4. SEE SITE DEVELOPMENT PLAN FOR LOCATION AND CONFIGURATION OF ACCESSIBLE SPACES.
 5. MAXIMUM 2% SLOPE SHALL BE MAINTAINED ACROSS ENTIRE ACCESSIBLE AREA.

No.	Revision	Date

Designed by: TDD Drawn by: BRC Checked by: DMF

Construction Details
Commercial Development
Inside Out Painting and Remodeling
100 Lowell Road
Hudson, NH
 Assessors Map 198 Lot 147

 Windham, New Hampshire Portland, Maine (603) 647-8700 www.sfeng.com

Sheet 8 of 9 Scale: 1" = 20' Date: 10/2/2024



Prepared for:
100 Lowell Road LLC
122 Lowell Road, Suite 3
Hudson, NH 03501

Hudson Planning Board
Approval

Zoning Classification: B - Business

APPROVED BY HUDSON, NH PLANNING BOARD

DATE OF MEETING: _____

SIGNATURE

SIGNATURE


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SIGNATURE DATE


PURSUANT TO THE SITE REVIEW REGULATIONS OF THE HUDSON PLANNING BOARD, THE SITE PLAN APPROVAL GRANTED HEREIN EXPIRES ONE YEAR FROM DATE OF APPROVAL.

SITE PLANS ARE VALID FOR TWO YEARS FROM THE DATE OF PLANNING BOARD MEETING DATE AT WHICH THE PLAN RECEIVES FINAL APPROVAL.

Drawing Name: 46102710-Inside-Out Painting - 400 Lowell Rd Hudson NH - Hamilton AutoCAD/InRoads/Construction Details.dwg

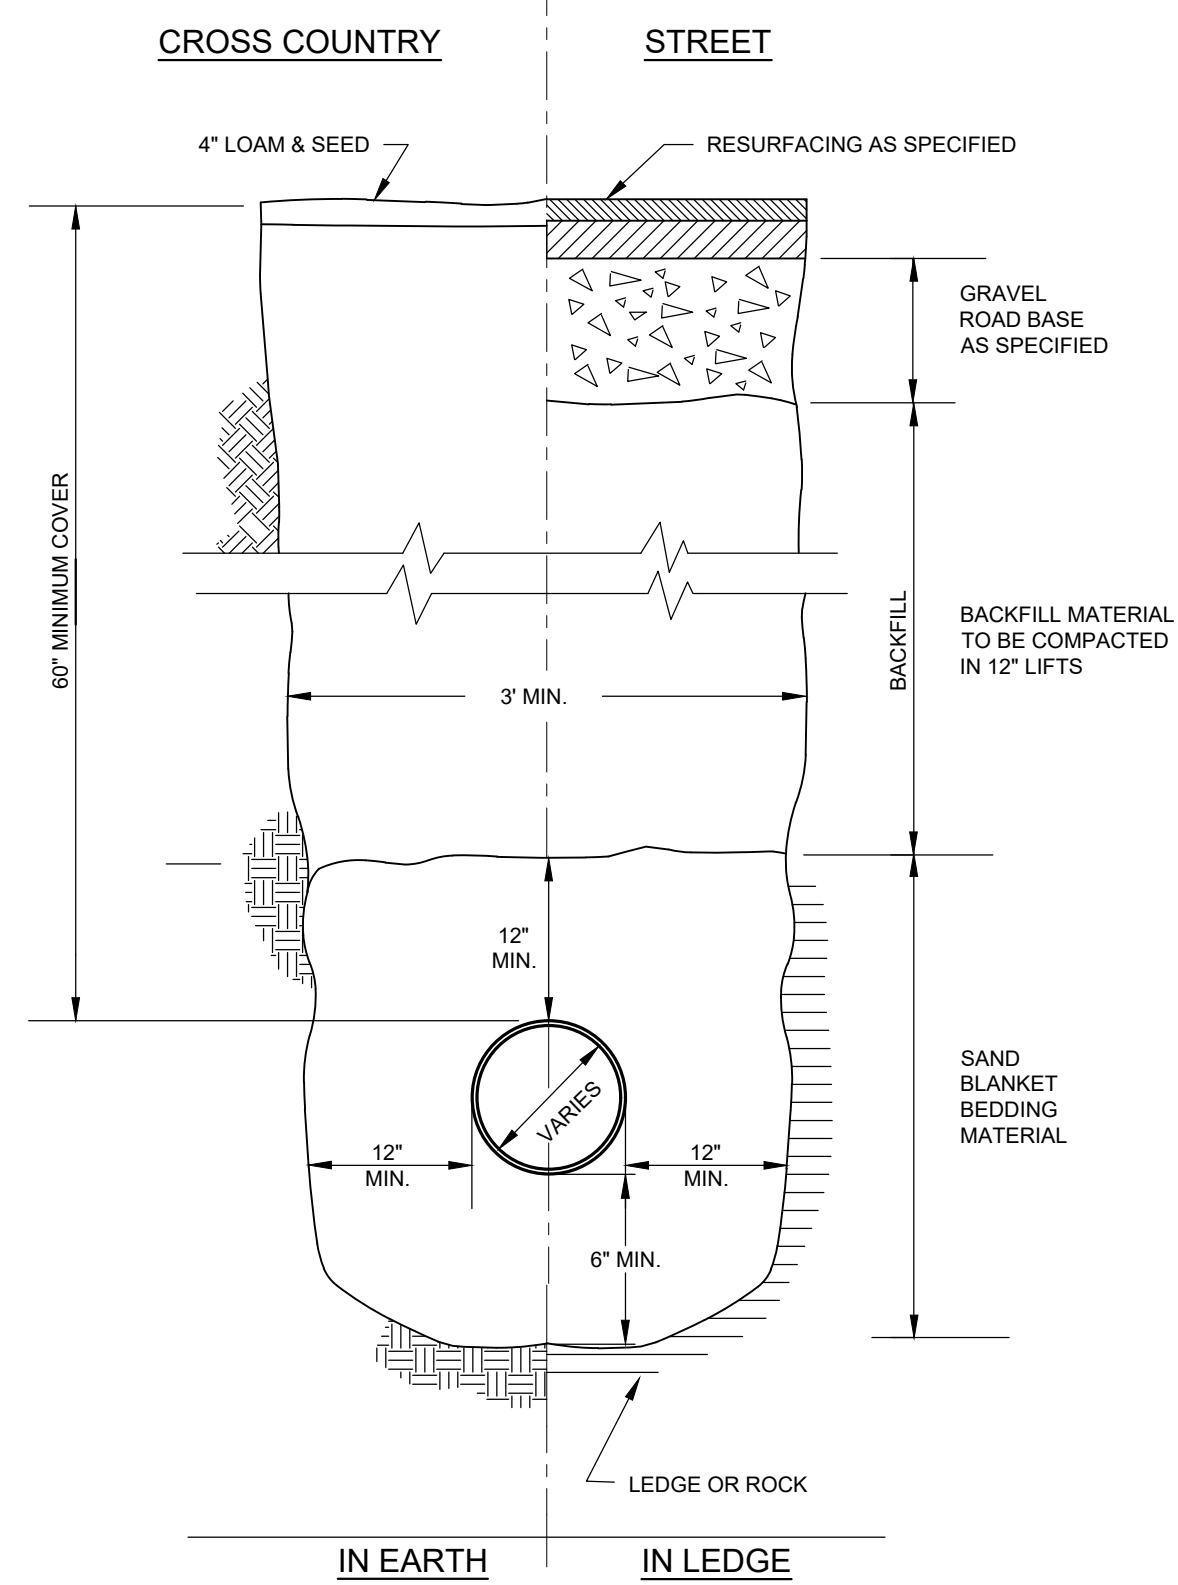

TYPICAL TRENCH SECTION FOR WATER SERVICE
NOT TO SCALE

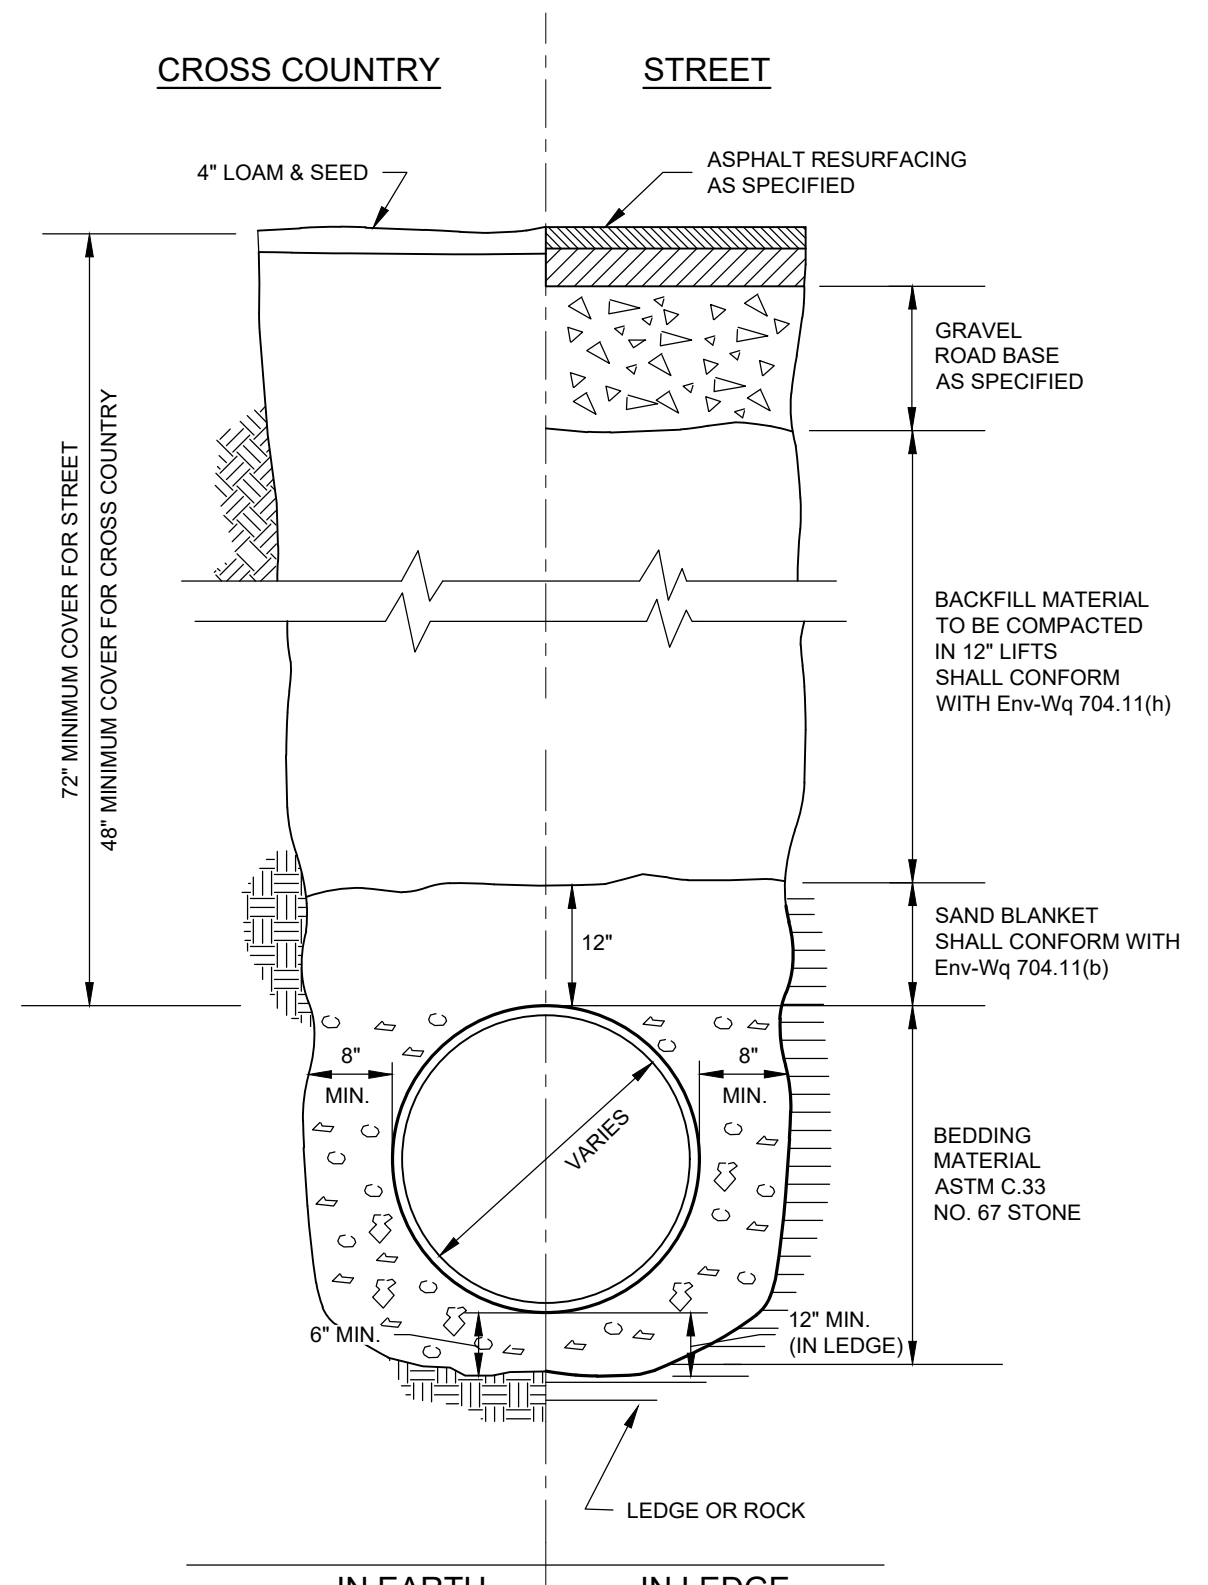

TYPICAL TRENCH SECTION FOR SANITARY SEWER SERVICE
NOT TO SCALE

SOIL DATA
TP# 1 8/29/2024

0-4"	4"	10YR 2/3 SANDY LOAM MOIST, MASSIVE LOOSE
4-36"	32"	2.5Y 6/4 MEDIUM SAND MOIST, SINGLE GRAIN LOOSE
36-90"	54"	2.5y 6/3 MEDIUM TO COURSE GRAVELY SAND, SINGLE GRAIN LOOSE

ESHWT: 90"
OBS. WATER: N/O
REFUSAL: N/O
ROOTS: 6"
%STONE/BOULDERS: 0/0
RESTRICTIVE LAYER: N/O

SOIL DATA
TP# 2 8/29/2024

0-4"	4"	10YR 4/3 SANDY LOAM MOIST, MASSIVE LOOSE
4-36"	32"	2.5Y 6/4 LOAMY SAND MOIST, SINGLE GRAIN LOOSE
36-84"	48"	2.5Y 6/3 MEDIUM TO COURSE GRAVELY SAND, SINGLE GRAIN LOOSE


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OBS. WATER: N/O
REFUSAL: N/O
ROOTS: 10"
%STONE/BOULDERS: 0/0
RESTRICTIVE LAYER: N/O

SOIL DATA
TP# 3 8/29/2024


0-4"	4"	10YR 4/3 SANDY LOAM MOIST, MASSIVE LOOSE
4-84"	84"	2.5Y 4/4 LOAMY SAND MOIST, SINGLE GRAIN VERY FRAGILE, MIX FILL WITH BROKEN CONCRETE OG BETWEEN 36-42"

ESHWT: 84"
OBS. WATER: N/O
REFUSAL: N/O
ROOTS: 42"
%STONE/BOULDERS: 0/0
RESTRICTIVE LAYER: N/O


TEST PIT LOGS

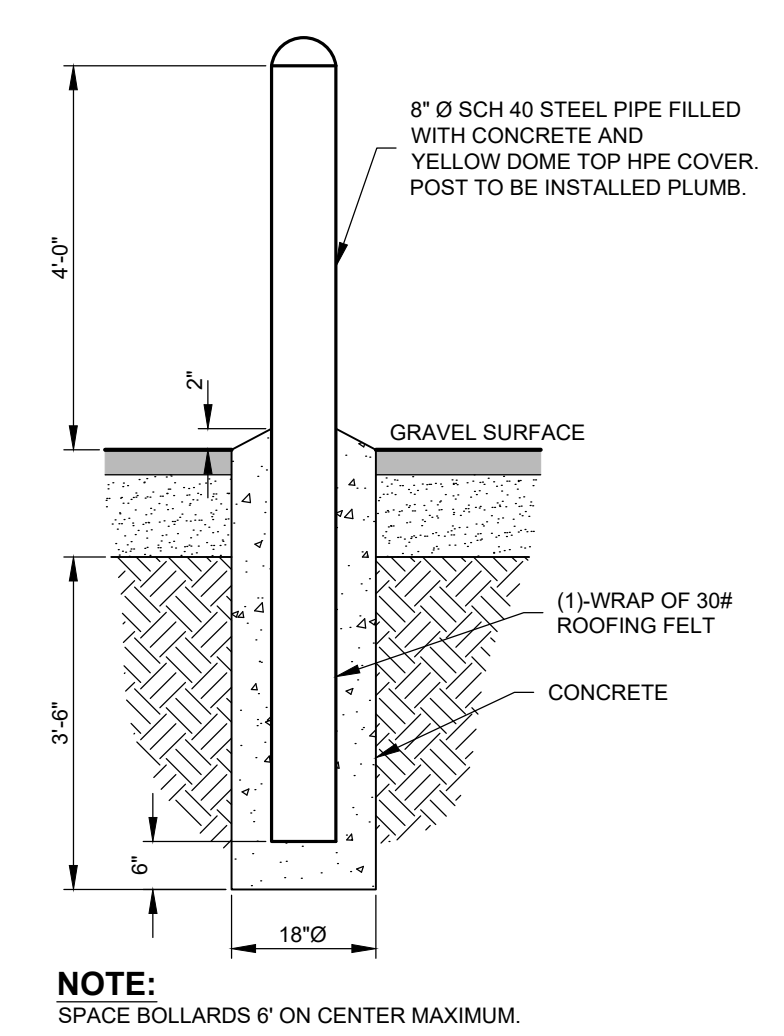



BOLLARD DETAIL
NOT TO SCALE

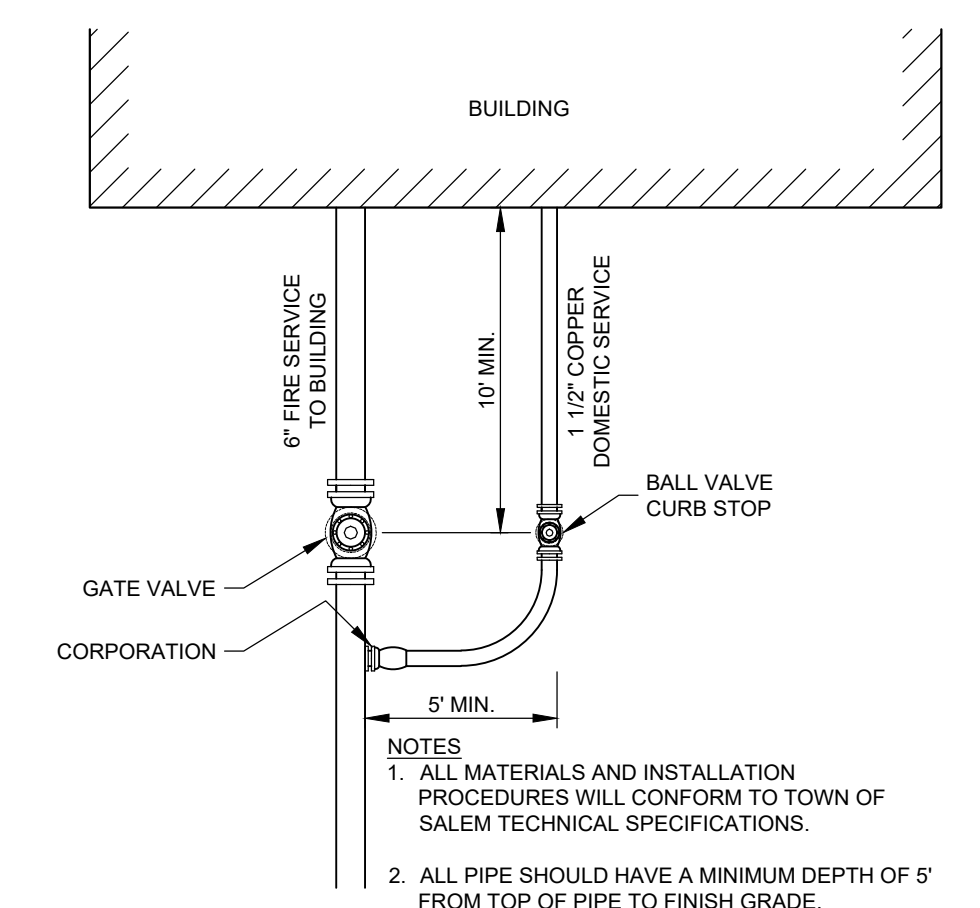

BUILDING WATER SERVICE
NOT TO SCALE

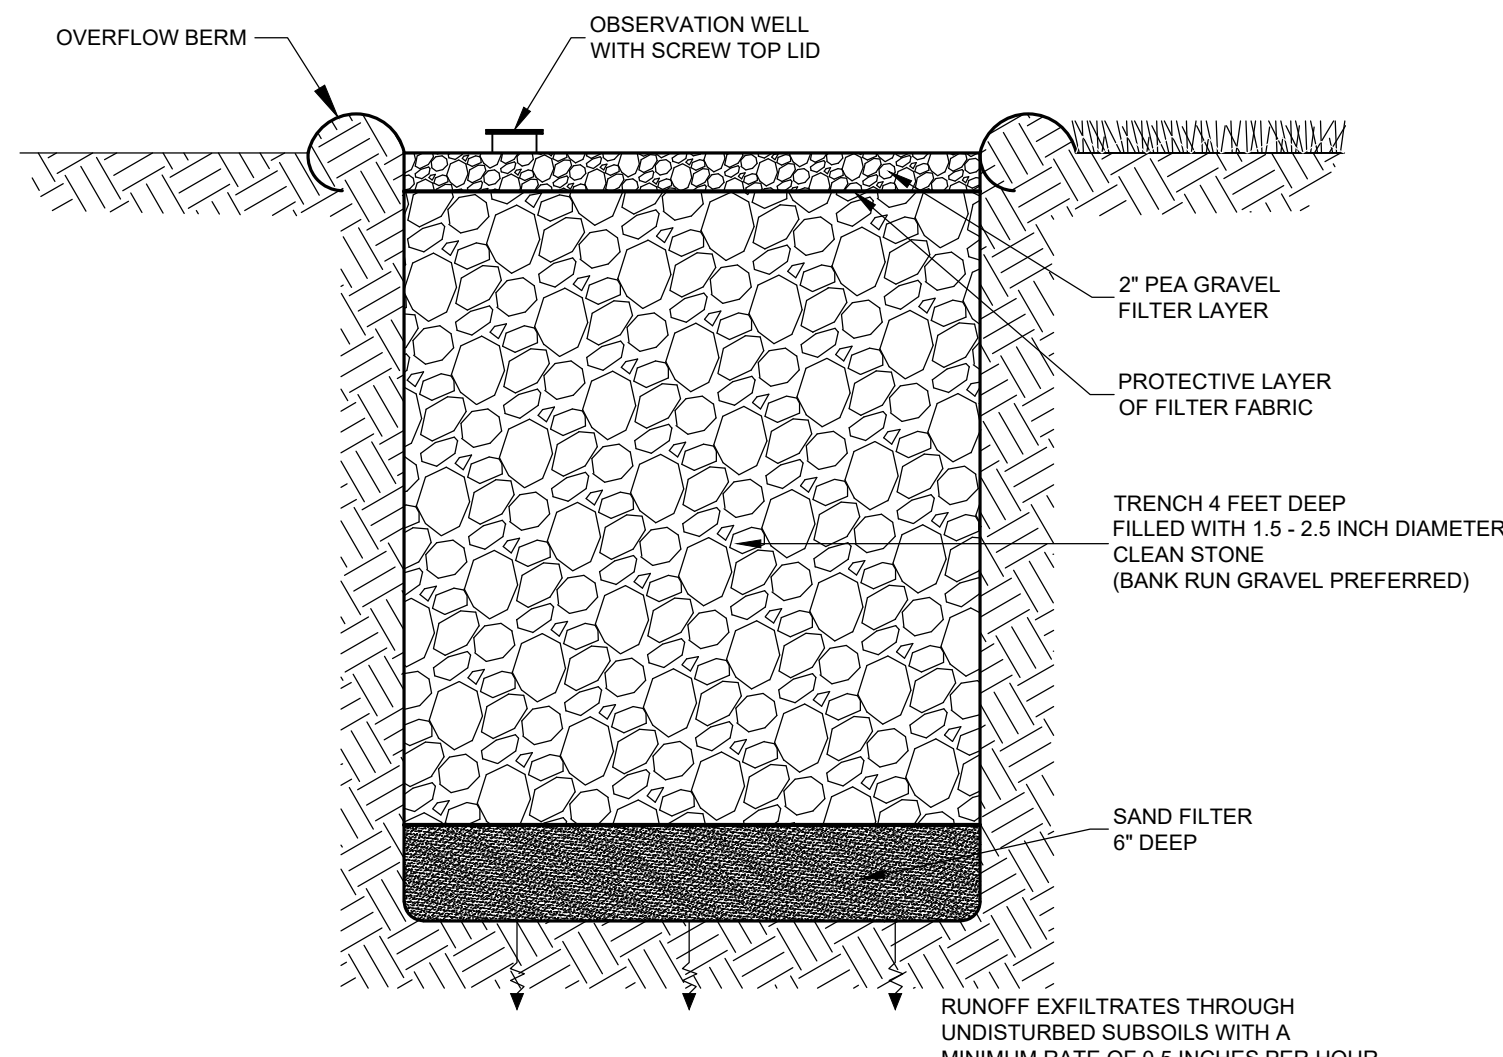

INFILTRATION TRENCH CROSS SECTION
NOT TO SCALE

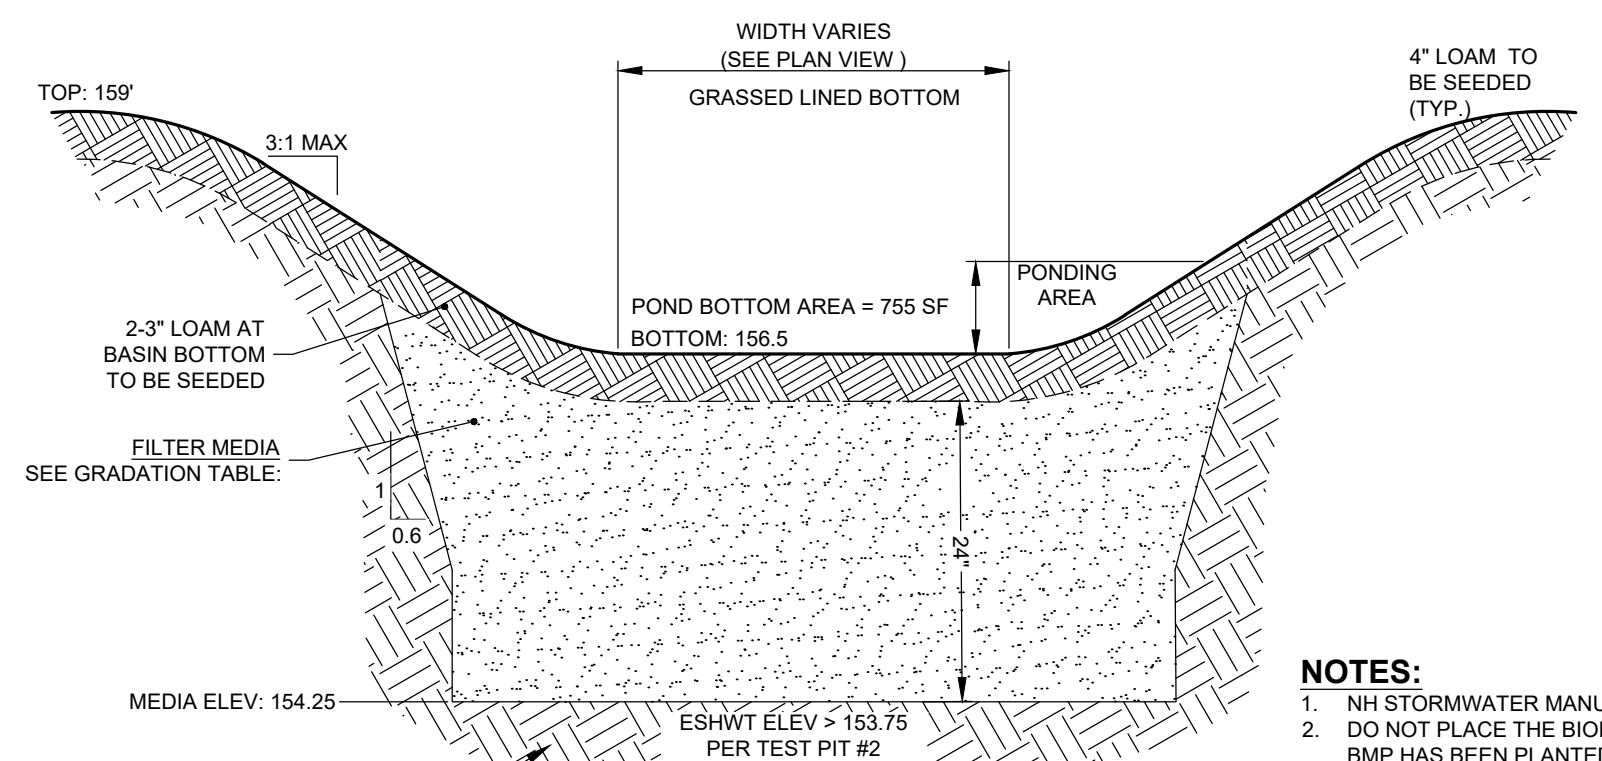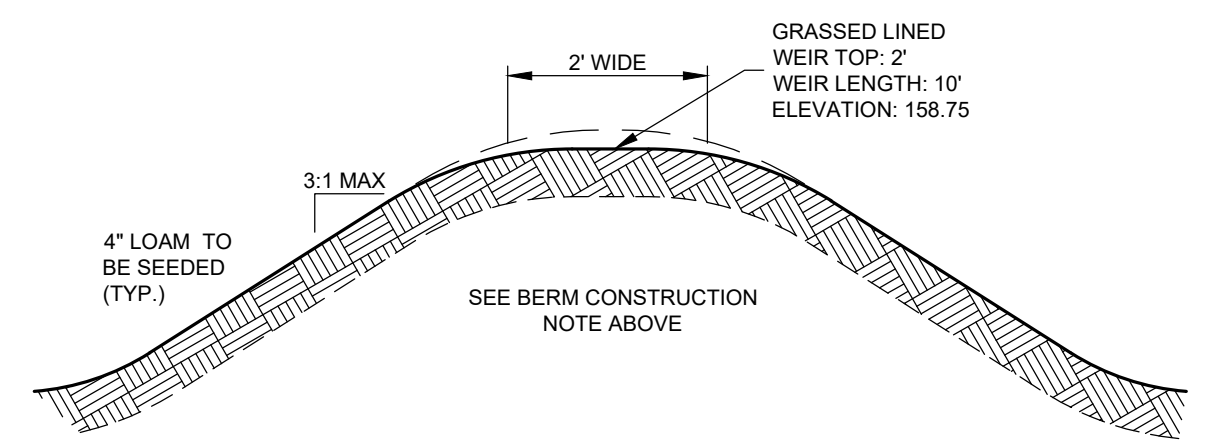

BIORETENTION SYSTEM
NOT TO SCALE

BIORETENTION MEDIA GRADATION TABLE

COMPONENT MATERIAL	PERCENT OF MIXTURE BY VOLUME	SIEVE NO.	GRADATION OF MATERIAL PERCENT BY WEIGHT PASSING STANDARD SIEVE
MODERATELY FINE SHREDDED BARK OR WOOD FIBER MULCH	20 TO 30	200	<5
LOAMY COARSE SAND	70 TO 80	10	85 TO 100
		20	70 TO 100
		60	15 TO 40
		200	8 TO 15

- NOTES:**
- NH STORMWATER MANUAL REFERENCED FOR DESIGN CRITERIA
 - DO NOT PLACE THE BIORETENTION SYSTEM INTO SERVICE UNTIL THE BMP HAS BEEN PLANTED AND ITS CONTRIBUTING AREAS HAVE BEEN FULLY STABILIZED.
 - DO NOT DISCHARGE SEDIMENT-LADEN WATERS FROM CONSTRUCTION ACTIVITIES (RUNOFF, WATER FROM EXCAVATIONS) TO THE BIORETENTION AREA DURING ANY STAGE OF CONSTRUCTION.
 - DO NOT TRAFFIC EXPOSED SOIL SURFACE WITH CONSTRUCTION EQUIPMENT. IF FEASIBLE, PERFORM EXCAVATIONS WITH EQUIPMENT POSITIONED OUTSIDE THE LIMITS OF THE INFILTRATION COMPONENTS OF THE SYSTEM.

APPROVED BY HUDSON, NH PLANNING BOARD

DATE OF MEETING: _____

SIGNATURE

SIGNATURE

SIGNATURE DATE

SIGNATURE DATE

PURSUANT TO THE SITE REVIEW REGULATIONS OF THE HUDSON PLANNING BOARD, THE SITE PLAN APPROVAL GRANTED HEREIN EXPIRES ONE YEAR FROM DATE OF APPROVAL.

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ENGINEERING

Windham, New Hampshire
Portland, Maine

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Sheet 9 of 9 Scale: 1" = 20' Date: 10/2/2024

Prepared for: 100 Lowell Road LLC 122 Lowell Road, Suite 3 Hudson, NH 03501	Hudson Planning Board Approval
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Zoning Classification: B - Business

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